

0.07 0 0.04 0.07 Miles

WGS_1984_Web_Mercator_Auxiliary_Sphere
© Latitude Geographics Group Ltd.

1:2,256

This map is a user generated static output from an Internet mapping site and is for reference only. Data layers that appear on this map may or may not be accurate, current, or otherwise reliable.

THIS MAP IS NOT TO BE USED FOR NAVIGATION

Planning Permit Application Form

455 County Center, 2nd Floor • Redwood City CA 94063
Mail Drop: PLN 122 • TEL (650) 363-4161 • FAX (650) 363-4849
www.co.sanmateo.ca.us/planning

PLN: _____
BLD: _____

Applicant/owner information

Applicant: Bryce & Jovi Dewett
Mailing Address: 2230 Boxwood Dr.
San Jose, CA Zip: 95128
Phone, W: (909) 263-1278 H: _____
E-mail Address: jovi.johnston@hotmail.com FAX: _____

Name of Owner (1): <u>Same as applicant</u>	Name of Owner (2): _____
Mailing Address: _____	Mailing Address: _____
Zip: _____	Zip: _____
Phone, W: _____	Phone, W: _____
H: _____	H: _____
E-mail Address: _____	E-mail Address: _____

Project information

Project Location (address): <u>Virginia Ave</u> <u>Moss Beach, CA 94038</u>	Assessor's Parcel Numbers: <u>031-118-100</u>
Zoning: _____	Parcel/lot size: <u>5200</u> SF (Square Feet)

List all elements of proposed project: (e.g. access, size and location, primary and accessory structures, well, septic, tank)

New single story residence (11608 sq ft) with attached 2-car garage (390 sq ft.). Front entry stairs with landing. Small backyard composite deck. Completion of side perimeter fencing.

Describe Existing Site Conditions/Features (e.g. topography, water bodies, vegetation):

Vacant lot with no significant slope.

Describe Existing Structures and/or Development:

Vacant lot with no structures or trees/vegetation.

Signatures

We hereby certify that the information stated above and on forms, plans and other materials submitted herewith in support of the application is true and correct to the best of our knowledge. It is our responsibility to inform the County of San Mateo through our assigned project planner of any changes to information represented in these submittals.

Owner's signature: [Signature]
Owner's signature: [Signature]
Applicant's signature: [Signature]

Planning and Building Department

Application for Design Review by the County Coastside Design Review Committee

County Government Center ■ 455 County Center ■ Redwood City CA 94063
Mail Drop PLN 122 ■ 650 • 363 • 4161 ■ FAX 650 • 363 • 4849

Permit #: PLN _____

Other Permit #: _____

1. Basic Information

Applicant:

Name: Bryce and Jovi DeWett

Address: 2230 Boxwood Dr.

San Jose, CA Zip: 95128

Phone,W: 9092631278 H:

Email: jovijohnston@hotmail.com

Owner (if different from Applicant):

Name:

Address: [Redacted]

Zip: [Redacted]

Phone,W: H:

Email:

Architect or Designer (if different from Applicant):

Name: Cutting Edge Homes

Address: 270 Douglas Ave. El Cajon, CA Zip: 92020

Phone,W: 87706808175 H: Email: chris@cuttingedgehomes.net

2. Project Site Information

Project location:

APN: 037118100

Address: Virginia Ave.

Moss Beach, CA Zip:

Zoning:

Parcel/lot size: 5200 sq. ft.

Site Description:

- vacant parcel
existing development (Please describe):

3. Project Description

Project:

- New Single Family Residence: _____ sq. ft
Addition to Residence: _____ sq. ft
Other: _____

Describe Project:

Modest single family residence (1608 sq. ft)
with 390 sq ft attached garage.

Additional Permits Required:

- Certificate of Compliance Type A or Type B
Coastal Development Permit
Fence Height Exception (not permitted on coast)
Grading Permit or Exemption
Home Improvement Exception
Non-Conforming Use Permit
Off-Street Parking Exception
Variance

4. Materials and Finish of Proposed Buildings or Structures

Fill in Blanks:	Material	Color/Finish <small>(If different from existing, attach sample)</small>	Check if matches existing
a. Exterior walls	Hardie CemPlank Siding	Westchester Gray	<input type="checkbox"/>
b. Trim		Nuance	<input type="checkbox"/>
c. Windows	Vinyl	White	<input type="checkbox"/>
d. Doors	Front (wood) Garage (alum.)	Medium wood stain	<input type="checkbox"/>
e. Roof	Corning supreme shingle	Onyx black	<input type="checkbox"/>
f. Chimneys	N/A		<input type="checkbox"/>
g. Decks & railings	Composite	Medium wood look	<input type="checkbox"/>
h. Stairs	Concrete(front)		<input type="checkbox"/>
i. Retaining walls	N/A		<input type="checkbox"/>
j. Fences	Wood	Match existing	<input checked="" type="checkbox"/>
k. Accessory buildings	N/A		<input type="checkbox"/>
l. Garage/Carport	Same as residence		<input type="checkbox"/>


5. Required Findings


To approve this application, the County must determine that this project complies with all applicable regulations including the required findings that the project does conform to the standards and guidelines for design review applicable to the location of the project pursuant to Section 6565.10.

- (optional) Applicant's Statement of project compliance with standards and guidelines (check if attached).

6. Signatures

I hereby certify that the information stated above and on forms, plans, and other materials submitted herewith in support of the application is true and correct to the best of my knowledge. It is my responsibility to inform the County of San Mateo through my assigned project planner of any changes to information represented in these submittals.

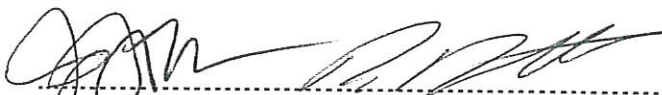
Owner: _____


Applicant: _____

1/5/2018
Date: _____

1/5/2018
Date: _____

Application for a Coastal Development Permit

Companion Page

Applicant's Name: Bryce & Jovi DeWett

Primary Permit #: _____

1. Instructions

Please fill out the general Planning Permit Application Form and this form when applying for a Coastal Development Permit. You must also submit all items indicated on the checklist found on the reverse side of the Planning Permit Application Form.

2. Basic Information

Does the owner or applicant own any adjacent property not listed?

Yes No

Have you or anyone else previously applied to either the County of San Mateo or the California Coastal Commission for a Coastal Development Permit for this or a similar project at this location?

Yes No

If yes, explain (include date and application file numbers).

If yes, list Assessor's Parcel Number(s):

3. Materials and Finish of Proposed Buildings or Structures

Note: By completing this section you do not need to file a separate application for Design Review Approval.

Fill in Blanks:	Material	Color/Finish	Check if matches existing
a. Exterior Walls	FIBER-CEMENT LAP SIDING	WESTCHESTER GRAY	<input type="checkbox"/>
b. Trim	HARDIE TRIM	NUANCE SW7049	<input type="checkbox"/>
c. Roof	ARCHIT. SUPREME SHINGLE	ONYX BLACK	<input type="checkbox"/>
d. Chimneys	N/A	N/A	<input type="checkbox"/>
e. Accessory Buildings	N/A	N/A	<input type="checkbox"/>
f. Decks/Stairs			<input type="checkbox"/>
g. Retaining Walls	N/A	N/A	<input type="checkbox"/>
h. Fences	EXISTING/Comp. Perimeter	EXISTING	<input type="checkbox"/>
i. Storage Tanks	N/A	N/A	<input type="checkbox"/>

4. Project Information

Does this project, the parcel on which it is located or the immediate vicinity involve or include:

- | | Yes | No |
|---|-------------------------------------|-------------------------------------|
| a. Demolition of existing housing units? (If yes, give value of owner-occupied units or current monthly rent of rental units in explanation below.) | <input type="checkbox"/> | <input checked="" type="checkbox"/> |
| b. Creeks, streams, lakes or ponds? | <input type="checkbox"/> | <input checked="" type="checkbox"/> |
| c. Wetlands (marshes, swamps, mudflats)? | <input type="checkbox"/> | <input checked="" type="checkbox"/> |
| d. Beaches? | <input type="checkbox"/> | <input checked="" type="checkbox"/> |
| e. Sand Dunes? | <input type="checkbox"/> | <input checked="" type="checkbox"/> |
| f. Sea cliff, coastal bluffs or blufftops? | <input type="checkbox"/> | <input checked="" type="checkbox"/> |
| g. Ridgetops? | <input type="checkbox"/> | <input checked="" type="checkbox"/> |
| h. Pampas Grass, invasive brooms or Weedy Thistle? | <input type="checkbox"/> | <input checked="" type="checkbox"/> |
| i. Removal of trees or vegetation? | <input type="checkbox"/> | <input checked="" type="checkbox"/> |
| j. Grading or alteration of landforms? | <input type="checkbox"/> | <input checked="" type="checkbox"/> |
| k. Landscaping? | <input checked="" type="checkbox"/> | <input type="checkbox"/> |
| l. Signs? | <input type="checkbox"/> | <input checked="" type="checkbox"/> |
| m. Phone or utility line extensions or connections, either above or below ground (explain which)? | <input type="checkbox"/> | <input checked="" type="checkbox"/> |
| n. Areas subject to flooding? | <input type="checkbox"/> | <input checked="" type="checkbox"/> |
| o. Development on slopes 30% or steeper? | <input type="checkbox"/> | <input checked="" type="checkbox"/> |

- | | | |
|--|--------------------------|-------------------------------------|
| p. Between the sea and the nearest public road? | <input type="checkbox"/> | <input checked="" type="checkbox"/> |
| q. Existing or proposed provisions for public access to the shoreline? | <input type="checkbox"/> | <input checked="" type="checkbox"/> |
| r. Public or commercial recreation facilities? | <input type="checkbox"/> | <input checked="" type="checkbox"/> |
| s. Visitor-serving facilities? | <input type="checkbox"/> | <input checked="" type="checkbox"/> |
| t. Existing or proposed public trail easements? | <input type="checkbox"/> | <input checked="" type="checkbox"/> |

Explain all Yes answers below. Indicate whether the item applies to the project itself, the parcel on which it is located, or the immediate vicinity (attach additional sheets if necessary):

MODEST WATER SAFE LANDSCAPING AS PER LANDSCAPE PLAN.

5. Staff Use Only

California Coastal Commission Jurisdiction

A. Does the Proposed Project Involve:

- A subdivision, Certificate of Compliance Type B, Use Permit, or Planned Agricultural District Permit?
 Yes No
- Construction or grading within 100 feet of a stream or wetland?
 Yes No
- A parcel located between the sea and the first public through road paralleling the sea; 300 feet from the inland extent of any beach or mean high tide line if there is no beach; or within 300 feet of the top of the seaward face of a coastal bluff?
 Yes No

Yes to any one of the above means that the Coastal Development Permit is appealable to the Coastal

Commission; a public hearing is always required.

B. Does the proposed project involve lands below the mean high tide line and lands where the public trust may exist? (See "Post CCP Certification Permit and Appeal Jurisdiction Map).

- Yes No

Yes to above means that the California Coastal Commission retains permit jurisdiction over all or part of the proposed project. A Coastal Development Permit from that agency is required.

Reviewed by: _____

Environmental Information Disclosure Form

Planning and Building Department

PLN _____

BLD _____

Project Address: Virginia Ave.
Moss Beach, CA 94038

Name of Owner: Bryce and Jovi DeWett
Address: 2230 Boxwood Dr
San Jose, CA 95128 Phone: 9092631278

Assessor's Parcel No.: 037 _ 118 _ 100

Name of Applicant: Bryce and Jovi DeWett
Address: 2230 Boxwood Dr San Jose, CA
95128 Phone: 9092631278

Zoning District: R1-S17

Existing Site Conditions

Parcel size: 5200 SF

Describe the extent and type of all existing development and uses on the project parcel, including the existence and purpose of any easements on the parcel, and a description of any natural features on the project parcel (i.e. steep terrain, creeks, vegetation).

We would like to build a single story, single family residence with attached garage. There are no easements & no vegetation.

Environmental Review Checklist

1. California Environmental Quality Act (CEQA) Review

Yes	No	Will this project involve:
<input checked="" type="checkbox"/>	<input type="checkbox"/>	a. Addition to an existing structure > 50% of the existing area OR > 2,500 sq. ft?
<input type="checkbox"/>	<input checked="" type="checkbox"/>	b. Construction of a new multi-family residential structure having 5 or more units?
<input type="checkbox"/>	<input checked="" type="checkbox"/>	c. Construction of a commercial structure > 2,500 sq.ft?
<input type="checkbox"/>	<input checked="" type="checkbox"/>	d. Removal of mature tree(s) (≥ 6" d.b.h. in Emerald Lake Hills area or ≥ 12" d.b.h. in any residential zoning district)? If yes, how many trees to be removed? _____
<input checked="" type="checkbox"/>	<input type="checkbox"/>	e. Land clearing or grading? If yes, please state amount in cubic yards (c.y.): Excavation : <u>160</u> c.y. Fill: _____ c.y.
<input type="checkbox"/>	<input checked="" type="checkbox"/>	f. Subdivision of land into 5 or more parcels?
<input type="checkbox"/>	<input checked="" type="checkbox"/>	g. Construction within a State or County scenic corridor?
<input type="checkbox"/>	<input checked="" type="checkbox"/>	h. Construction within a sensitive habitat?
<input type="checkbox"/>	<input checked="" type="checkbox"/>	i. Construction within a hazard area (i.e. seismic fault, landslide, flood)?
<input type="checkbox"/>	<input checked="" type="checkbox"/>	j. Construction on a hazardous waste site (check with Co. Env. Health Division)?

Please explain all "Yes" answers:
New single family residence on vacant land.

Signature required on reverse →

2. National Marine Fisheries Rule 4(d) Review

Yes	No	Will the project involve:
<input type="checkbox"/>	<input checked="" type="checkbox"/>	a. Construction outside of the footprint of an existing, legal structure?
<input type="checkbox"/>	<input checked="" type="checkbox"/>	b. Exterior construction within 100-feet of a stream?
<input type="checkbox"/>	<input checked="" type="checkbox"/>	c. Construction, maintenance or use of a road, bridge, or trail on a stream bank or unstable hill slope?
<input type="checkbox"/>	<input checked="" type="checkbox"/>	d. Land-use within a riparian area?
<input type="checkbox"/>	<input checked="" type="checkbox"/>	e. Timber harvesting, mining, grazing or grading?
<input type="checkbox"/>	<input checked="" type="checkbox"/>	f. Any work inside of a stream, riparian corridor, or shoreline?
<input type="checkbox"/>	<input checked="" type="checkbox"/>	g. Release or capture of fish or commerce dealing with fish?

Please explain any "Yes" answers:

3. National Pollutant Discharge Elimination System (NPDES) Review

Yes	No	Will the project involve:
<input type="checkbox"/>	<input checked="" type="checkbox"/>	<p>a. <u>A subdivision or Commercial / Industrial Development that will result in the addition or replacement of 10,000 sq. ft. or more of impervious surface?</u></p> <p>If yes, Property Owner may be required to implement appropriate source control and site design measures and to design and implement stormwater treatment measures, to reduce the discharge of stormwater pollutants. Please consult the Current Planning Section for necessary forms and both construction and post-construction requirements.</p>
<input type="checkbox"/>	<input checked="" type="checkbox"/>	<p>b. <u>Land disturbance of 1 acre or more of area?</u></p> <p>If yes, Property Owner must file a Notice of Intent (NOI) to be covered under the statewide General Construction Activities Storm Water Permit (General Permit) <u>prior</u> to the commencement of construction activity. Proof of coverage under State permit must be demonstrated prior to the issuance of a building permit.</p>

Certification

I hereby certify that the statements furnished above and in the attached exhibits present the data and information required for this initial evaluation to the best of my ability, and the facts, statements and information presented are true and correct to the best of my knowledge and belief. **If any of the facts represented here change, it is my responsibility to inform the County.**

Signed: 
 (Applicant may sign)

Date: 1/4/2018

Dark sky compliant lighting fixture to be used:



Hampton Bay 1-Light Zinc Outdoor Wall Lantern

The Hampton Bay 1-Light Outdoor Zinc Wall Lantern is designed with an aged look that will enrich your home. Hand-painted in zinc and lightly stained, the lantern offers illuminating ambiance to a given outdoor area. Uses 1-60-Watt medium base bulb or CFL equivalent (not included).


- Durable steel construction with hand-painted zinc finish for charming look
- Uses 1-light 60-Watt medium based bulb or CFL equivalent
- Compatible with a standard wall dimmer
- UL certified
- Hardware included for ease of installation
- Design adds a modern touch to your living space
- Extra safe since no glass involved

BODY MATERIAL – LEVEL 1
NON-COMBUSTIBLE FIBER-CEMENT LAP SIDING
WOOD GRAINED TEXTURE
COLOR: WESTCHESTER GRAY (SEE PAGE 2)



SHERWIN WILLIAMS PAINT


COLOR: WESTCHESTER GRAY SW2849

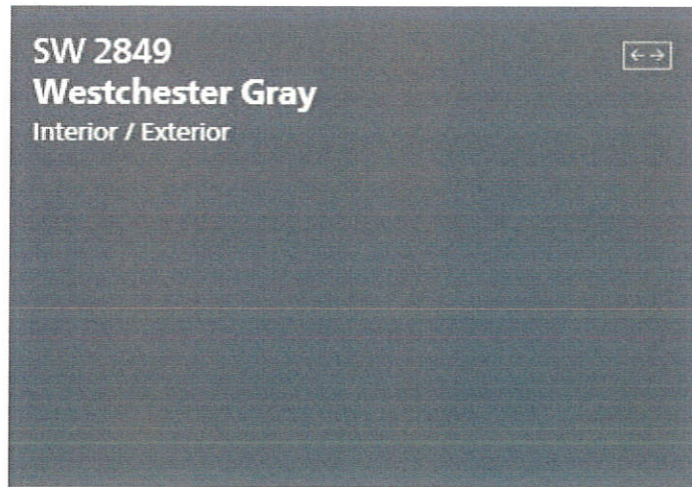

SHERWIN WILLIAMS PAINT

EXTERIOR TRIM

COLOR: NUANCE SW7049

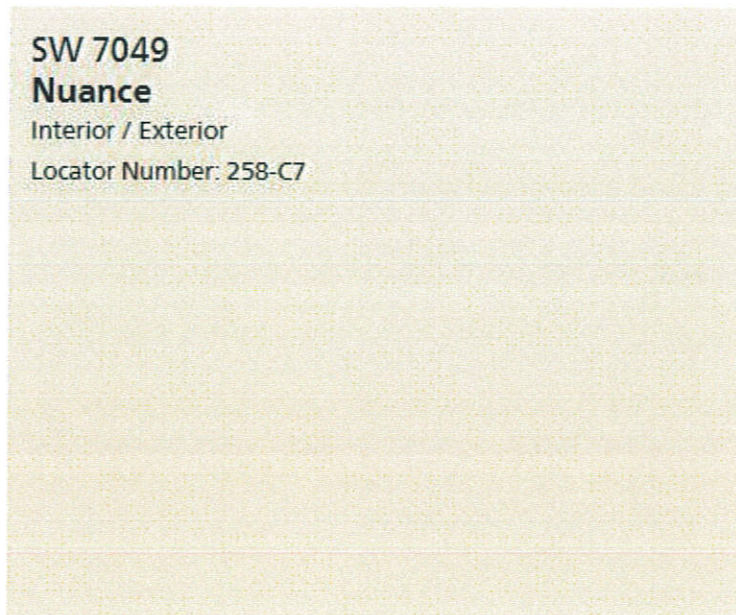


25 YEAR MINIMUM SHINGLES

ARCHITECTURAL / DIMENSIONAL STYLE

OWENS CORNING SUPREME SHINGLE

ONYX BLACK

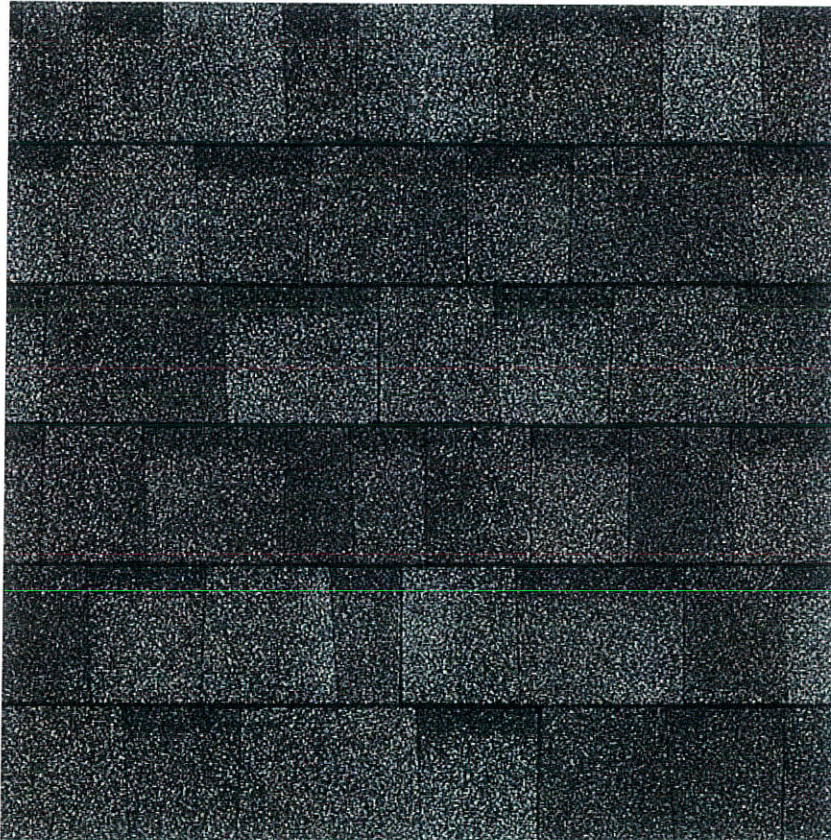

NPDES NOTES

NOTES MUST BE SHOWN AS WORDED, ON THE TITLE SHEET OF THE PLAN.

1. IN THE CASE OF EMERGENCY, CALL:
AT WORK PHONE #
OR CELL PHONE #

- 2. SEDIMENT FROM AREAS DISTURBED BY CONSTRUCTION SHALL BE RETAINED ON SITE USING STRUCTURAL CONTROLS TO THE MAXIMUM EXTENT PRACTICABLE.
3. STOCKPILES OF SOIL SHALL BE PROPERLY CONTAINED TO MINIMIZE SEDIMENT TRANSPORT FROM THE SITE TO STREETS, DRAINAGE FACILITIES OR ADJACENT PROPERTIES VIA RUNOFF, VEHICLE TACKING, OR WIND.
4. APPROPRIATE BMPs FOR CONSTRUCTION - RELATED MATERIALS, WASTES, SPILLS SHALL BE IMPLEMENTED TO MINIMIZE TRANSPORT FROM THE SITE TO STREETS, DRAINAGE FACILITIES, OR ADJOINING PROPERTIES BY WIND OR RUNOFF.
5. RUNOFF FROM EQUIPMENT AND VEHICLE WASHING SHALL BE CONTAINED AT CONSTRUCTION SITES UNLESS TREATED TO REDUCE OR REMOVE SEDIMENT AND OTHER POLLUTANTS.
6. ALL CONSTRUCTION CONTRACTOR AND SUBCONTRACTOR PERSONNEL ARE TO BE MADE AWARE OF THE REQUIRED BEST MANAGEMENT PRACTICES AND GOOD HOUSEKEEPING MEASURES FOR THE PROJECT SITE AND ANY ASSOCIATED CONSTRUCTION STAGING AREAS.
7. AT THE END OF EACH DAY OF CONSTRUCTION ACTIVITY ALL CONSTRUCTION DEBRIS AND WASTE MATERIALS SHALL BE COLLECTED AND PROPERLY DISPOSED IN TRASH OR RECYCLE BINS.
8. CONSTRUCTION SITES SHALL BE MAINTAINED IN SUCH A CONDITION THAT AN ANTICIPATED STORM DOES NOT CARRY WASTES OR POLLUTANTS OFF THE SITE. DISCHARGES OF MATERIAL OTHER THAN STORM WATER ONLY WHEN NECESSARY FOR PERFORMANCE AND COMPLETION OF CONSTRUCTION PRACTICES AND WHERE THEY DO NOT CAUSE OR CONTRIBUTE TO A VIOLATION OF ANY WATER QUALITY STANDARD, CAUSE OR THREATEN TO CAUSE POLLUTION, CONTAMINATION, OR NUISANCE; OR CONTAIN A HAZARDOUS SUBSTANCE IN A QUANTITY REPORTABLE UNDER FEDERAL REGULATIONS 40 CFR PARTS 117 AND 302.
9. POTENTIAL POLLUTANTS INCLUDE BUT ARE NOT LIMITED TO: SOLID OR LIQUID CHEMICAL SPILLS; WASTES FROM PAINTS, STAINS, SEALANTS, GLUES, LIMES, PESTICIDES, HERBICIDES, WOOD PRESERVATIVES AND SOLVENTS; ASBESTOS FIBERS, PAINT FLAKES OR STUCCO FRAGMENTS; FUELS, OILS, LUBRICANTS, AND HYDRAULIC, RADIATOR OR BATTERY FLUIDS; FERTILIZERS, VEHICLE/EQUIPMENT WASH WATER AND CONCRETE WASH WATER; CONCRETE, DETERGENT OR FLOATABLE WASTES; WASTES FROM ANY ENGINE/EQUIPMENT STEAM CLEANING OR CHEMICAL DEGREASING AND SUPER - CHLORINATED POTABLE WATER LINE FLUSHING. DURING CONSTRUCTION, PERMITTEE SHALL DISPOSE OF SUCH MATERIALS IN A SPECIFIED AND CONTROLLED TEMPORARY AREA ON - SITE, PHYSICALLY SEPARATED FROM POTENTIAL STORM WATER RUNOFF, WITH ULTIMATE DISPOSAL IN ACCORDANCE WITH LOCAL, STATE AND FEDERAL REQUIREMENTS.
10. DE - WATERING OF CONTAMINATED GROUNDWATER, OR DISCHARGING CONTAMINATED SOILS VIA SURFACE EROSION IS PROHIBITED. DE - WATERING OF NON - CONTAMINATED GROUNDWATER REQUIRES A NATIONAL POLLUTANT DISCHARGE ELIMINATION SYSTEM PERMIT FROM THE RESPECTIVE STATE REGIONAL WATER QUALITY CONTROL BOARD.
11. GRADED AREAS ON THE PERMITTED AREA PERIMETER MUST DRAIN AWAY FROM THE FACE OF SLOPES AT THE CONCLUSION OF EACH WORKING DAY. DRAINAGE IS TO BE DIRECTED TOWARD DE- SILTING FACILITIES.
12. THE PERMITTEE AND CONTRACTOR SHALL BE RESPONSIBLE AND SHALL TAKE NECESSARY PRECAUTIONS TO PREVENT PUBLIC TRESPASS ONTO AREAS WHERE IMPOUNDED WATER CREATES A HAZARDOUS CONDITION.
13. THE PERMITTEE AND CONTRACTOR SHALL INSPECT THE EROSION CONTROL WORK AND INSURE THAT THE WORK IS IN ACCORDANCE WITH THE APPROVED PLANS.
14. THE PERMITTEE SHALL NOTIFY ALL GENERAL CONTRACTORS, SUBCONTRACTORS, MATERIAL SUPPLIERS, LESSEES, AND PROPERTY OWNERS THAT DUMPING OF CHEMICALS INTO THE STORM DRAIN SYSTEM OR THE WATERSHED IS PROHIBITED.
15. EQUIPMENT AND WORKERS FOR EMERGENCY WORK SHALL BE MADE AVAILABLE AT ALL TIMES DURING THE RAINY SEASON. NECESSARY MATERIALS SHALL BE AVAILABLE ON SITE AND STOCKPILED AT CONVENIENT LOCATIONS TO FACILITATE RAPID CONSTRUCTION OF TEMPORARY DEVICES WHEN RAIN IS IMMINENT.
16. ALL REMOVABLE EROSION PROTECTIVE DEVICES SHALL BE IN PLACE AT THE END OF EACH WORKING DAY WHEN THE 5 - DAY RAIN PROBABILITY FORECAST EXCEEDS 40%.
17. SEDIMENTS FROM AREAS DISTURBED BY CONSTRUCTION SHALL BE RETAINED ON SITE USING AN EFFECTIVE COMBINATION OF EROSION AND SEDIMENT CONTROLS TO THE MAXIMUM EXTENT PRACTICABLE, AND STOCKPILES OF SOIL SHALL BE PROPERLY CONTAINED TO MINIMIZE SEDIMENT TRANSPORT FROM THE SITE TO STREETS, DRAINAGE FACILITIES OR ADJACENT PROPERTIES VIA RUNOFF, VEHICLE TRACKING, OR WIND.
18. APPROPRIATE BMPs FOR CONSTRUCTION - RELATED MATERIALS, WASTES, SPILLS OR RESIDUES SHALL BE IMPLEMENTED AND RETAINED ON SITE TO MINIMIZE TRANSPORT FROM THE SITE TO STREETS, DRAINAGE FACILITIES, OR ADJOINING PROPERTY BY WIND OR RUNOFF.

APPLICABLE CODE:

- 2016 CALIFORNIA BUILDING CODE
2016 CALIFORNIA ELECTRICAL CODE
2016 CALIFORNIA MECHANICAL CODE
2016 CALIFORNIA PLUMBING CODE
2016 CALIFORNIA GREEN BUILDING CODE 2013 T-24 ENERGY CODE

VICINITY MAP



NEW CONSTRUCTION
DEWETT RESIDENCE



VIRGINIA AVENUE
MOSS BEACH, CA 94038

ABBREVIATIONS

Table with 3 columns: Abbreviation, Full Name, and Description. Includes entries for A/C, ABV, A.C.P, etc.

GREEN BUILDING CODE NOTES

- 1. THE CONSTRUCTION DOCUMENTS SHALL PROVIDE SUFFICIENT CLARIFY TO INDICATE THE LOCATION, NATURE, AND SCOPE OF THE PROPOSED GREEN BUILDING FEATURES. CGBC 102.2
2. PLUMBING FIXTURES AND FITTINGS SHALL MEET THE STANDARDS REFERENCED IN CGBC TABLE 4.303.3. CGBC 4303.3
3. SEAL OPENINGS IN THE BUILDING ENVELOPE IN COMPLIANCE WITH THE CALIFORNIA ENERGY CODE (CEC). AMMLAR SPACES AROUND PIPES, ELECTRIC CABLES, CONDUITS OR OTHER OPENINGS IN PLATES AT EXTERIOR WALLS SHALL BE PROTECTED BY CLOSING SUCH OPENINGS WITH CEMENT MORTAR, CONCRETE MASONRY, OR A SIMILAR METHOD ACCEPTABLE TO THE ENFORCING AGENCY. CGBC 4.408.1
4. REDUCE CONSTRUCTION WASTE BY RECYCLING OR SALVAGING FOR RE-USE A MINIMUM OF 50 PERCENT OF THE NONHAZARDOUS CONSTRUCTION AND DEMOLITION DEBRIS, OR MEET THE LOCAL CONSTRUCTION AND DEMOLITION WASTE MANAGEMENT ORDINANCE, WHICHEVER IS MORE STRINGENT. CGBC 4.408.1
5. CONSTRUCTION WASTE MANAGEMENT PLAN AND DOCUMENTATION DEMONSTRATING COMPLIANCE WITH THE PLAN SHALL BE SUBMITTED THAT:
A. IDENTIFIES THE MATERIALS TO BE DIVERTED FROM DISPOSAL BY RECYCLING, REUSE ON THE PROJECT OR SALVAGE FOR FUTURE USE OR SALE.
B. SPECIFICS IF MATERIALS WILL BE SORTED ON-SITE OR MIXED FOR TRANSPORTATION TO A DIVERSION FACILITY.
C. IDENTIFIES THE DIVERSION FACILITY WHERE THE MATERIAL COLLECTION WILL BE TAKEN.
D. IDENTIFIES CONSTRUCTION METHODS EMPLOYED TO REDUCE THE AMOUNT OF WASTE GENERATED.
E. SPECIFICS THAT THE AMOUNT OF MATERIALS
6. AN OPERATION AND MAINTENANCE MANUAL WITH CONTENT PER CGBC 4.410.1 AND IN A FORMAT ACCEPTABLE TO THE ENFORCING AGENCY SHALL BE PLACED IN THE BUILDING AT THE TIME OF FINAL INSPECTION. CGBC 4.410.1. REFER TO HCD RESIDENTIAL GUIDE FOR MANUAL FORMAT AND SUGGESTED CONTENT.
7. GAS FIREPLACES TO BE DIRECT-VENT SEALED-COMBUSTION TYPE. WOODSTOVES OR PELLET STOVES SHALL COMPLY WITH U.S. EPA PHASE II EMISSION LIMITS. CGBC 4.503.1 NOTE: REFERENCE SCAQMD RULE 445.
8. ALL DUCT OPENINGS AND OTHER AIR DISTRIBUTION COMPONENT OPENINGS SHALL BE PROTECTED DURING STORAGE ON THE CONSTRUCTION SITE UNTIL FINAL START-UP WITH TAPE, PLASTIC, SHEET METAL, OR OTHER ACCEPTABLE METHODS TO REDUCE THE AMOUNT OF DUST AND DEBRIS WHICH MAY COLLECT IN THE SYSTEM. CGBC 4.504.1
9. FINISH MATERIALS SHALL COMPLY WITH CGBC 4.504.2.
10. ADHESIVES, ADHESIVE BONDING PRIMERS, ADHESIVE PRIMERS, SEALANTS, SEALANT PRIMERS, AND CAULKS SHALL COMPLY WITH LOCAL OR REGIONAL AIR POLLUTION CONTROL OR AIR QUALITY MANAGEMENT DISTRICT RULES WHERE APPLICABLE, OR MEET THE REQUIREMENT OF SCAQMD RULE 1168 VOC LIMITS AND PROHIBITION ON THE USE OF CERTAIN TOXIC CHEMICALS, EXCEPT PER SUBSECTION 2. CGBC 4.504.2.1. SUBSECTION 1
11. AEROSOL ADHESIVES, SMALLER UNIT SIZES OF ADHESIVES, AND SEALANT OR CAULKING COMPOUNDS (IN UNITS OF PRODUCT, LESS PACKING, WHICH DO NOT WEIGH MORE THAN 1 POUND AND DO NOT CONSIST OF MORE THAN 16 FLUID OZ) SHALL COMPLY WITH STATEWIDE VOC STANDARDS AND OTHER REQUIREMENTS, INCLUDING PROHIBITIONS ON THE USE OF CERTAIN TOXIC COMPOUNDS, OF CCR, TITLE 17, COMMENCING WITH SECTION 94507.4 CGBC.504.2.1. SUBSECTION 2
12. VOC CONTENT LIMITS FOR ARCHITECTURAL COATINGS (ARCHITECTURAL PAINTS) SHALL COMPLY WITH CGBC TABLE 4.504.3.
13. AEROSOL PAINTS AND COATINGS SHALL MEET THE REQUIREMENTS OF SECTIONS 94522(A)(3), 94522(C)(2), AND (D)(2) OF CALIFORNIA CODE OF REGULATIONS, TITLE 17 COMMENCING WITH SECTION 94520. CGBC 4.504.2.3
14. VERIFICATION OF COMPLIANCE WITH FINISH MATERIALS SHALL BE PROVIDED AT THE REQUEST OF THE ENFORCING AGENCY. DOCUMENTS MAY INCLUDE, BUT NOT LIMITED TO THE FOLLOWING:
A. MANUFACTURER'S PRODUCT SPECIFICATION.
B. FIELD VERIFICATION OF ON-SITE PRODUCT CONTAINERS.
C. OTHER METHODS APPROVED BY THE LOCAL JURISDICTION.
15. CARPETS SHALL MEET ONE OF THE FOLLOWING: 1. CARPET AND RUG INSTITUTE'S GREEN LABEL PLUS PROGRAM, 2. CALIFORNIA DEPARTMENT OF PUBLIC HEALTH STANDARD PRACTICE FOR THE TESTING OF VOCs (SPECIFICATION 01350), 3. NSF/IANSI 140 AT THE GOLD LEVEL. 4. SCIENTIFIC CERTIFICATIONS SYSTEMS INDOOR ADVANTAGE™ GOLD. CGBC 4.504.3
16. CARPET CUSHION SHALL MEET THE REQUIREMENTS OF THE CARPET AND RUG INSTITUTE GREEN LABEL PROGRAM, CARPET ADHESIVE SHALL MEET THE REQUIREMENTS OF CGBC TABLE 4.504.1, CGBC 4.504.3.1, 4.504.3.2
17. FOR RESILIENT FLOORING, AT LEAST 50 PERCENT OF THE FLOOR AREA SHALL COMPLY WITH VOC EMISSION LIMITS DEFINED IN THE COLLABORATIVE FOR HIGH PERFORMANCE SCHOOLS (CH-PS) LOW-EMITTING MATERIALS LIST OR CERTIFIED UNDER THE RESILIENT FLOOR COVERING INSTITUTE (RFCI) FLOORSCORE PROGRAM. CGBC 4.504.4
18. HARDWOOD PLYWOOD, PARTICLEBOARD, AND MEDIUM DENSITY FIBERBOARD COMPOSITE WOOD PRODUCTS SHALL MEET THE REQUIREMENTS FOR FORMALDEHYDE LIMITS IN CGBC TABLE 4.504.5. CGBC 4.504.5
19. DOCUMENTATION SHALL BE PROVIDED TO INDICATE COMPLIANCE WITH CGBC 4.504 AND SHALL INCLUDE AT LEAST ONE OF THE FOLLOWING: PRODUCT CERTIFICATIONS AND SPECIFICATIONS, CHAIN OF CUSTODY CERTIFICATIONS, OR OTHER METHODS ACCEPTABLE TO THE ENFORCING AGENCY. CGBC 4.504.5.1
20. CONCRETE SLAB FOUNDATIONS REQUIRED TO HAVE A VAPOR RETARDER BY CBC, CCR TITLE 24, PART 2, CHAPTER 19 SHALL ALSO COMPLY WITH THIS SECTION. PROVIDE A CAPILLARY BREAK INSTALLED IN COMPLIANCE WITH ONE OF THE FOLLOWING:
A. A 4-INCH THICK BASE OF 1/2-INCH OR LARGER CLEAN AGGREGATE, WITH A VAPOR BARRIER IN DIRECT CONTACT WITH CONCRETE, AND A CONCRETE DESIGN WHICH WILL ADDRESS BLEEDING, SHRINKAGE, AND CURLING.
B. OTHER EQUIVALENT METHODS APPROVED BY THE ENFORCING AGENCY.
C. A SLAB DESIGN SPECIFIED BY A LICENSED DESIGN PROFESSIONAL. CGBC 4.505.2.1
D. REFERENCE ACI 302.
21. ADD A NOTE TO PLANS THE BUILDING MATERIALS WITH VISIBLE SIGNS OF WATER DAMAGE SHALL NOT BE INSTALLED. CGBC 4.505.3
22. MOISTURE CONTENT OF BUILDING MATERIALS, AND VERIFICATION, SHALL MEET THE REQUIREMENTS OF CGBC 4.505.3
23. BATHROOM EXHAUST FANS SHALL BE ENERGY STAR COMPLIANT, DUCTED TO TERMINATE OUTSIDE THE BUILDING, AND CONTROLLED BY A HUMIDSTAT CAPABLE OF BEING ADJUSTED BETWEEN THE RELATIVE HUMIDITY RANGE OF 50 TO 80 PERCENT. CGBC 4.506
24. COVERS FOR WHOLE HOUSE EXHAUST FANS SHALL HAVE A MINIMUM INSULATION VALUE OF R-4.2 AND CLOSE WHEN THE FAN IS OFF. CGBC 4.507.

OWNER:
Bryce Alexander DeWett and
Jovi DeWett
2230 Boxwood Drive,
San Jose, CA 95128
909-263-1278

HOME PROVIDER
CUTTING EDGE HOMES
270 E DOUGLAS AVE.
EL CAJON, CA 92020
877-680-8175

Table with 2 columns: Sheet Name, Sheet Number. Includes entries for Title Sheet, Site Plan, Floor Plans, etc.

SCOPE:

1. NEW SINGLE FAMILY RESIDENCE

PROJECT DATA:

BUILDING(S) OCCUPANCY: R-1
ZONING: R1/S17/DR/CD
CONSTRUCTION TYPE: V-B
STORIES: 1

Table with 2 columns: Name, Area. Includes LOT COVERAGE and PARCEL COVERAGE sections.

2141 (HOUSE+GARAGE+LANDINGS) / 5200 (LOT SIZE) X 100 = 41%

PARCEL COVERAGE = BUILDINGS, ACCESSORY BUILDINGS, OR STRUCTURES SUCH AS PATIOS, DECKS, BALCONIES, AND SIMILAR OVER 18" ABOVE GROUND.

BUILDING FLOOR AREA

HOUSE (1608 SF) + SITE BUILT GARAGE (390 SF) =
1998 SF / 5200 = 0.38 (MAX. 50)

APN: 037-118-100





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DEWETT RESIDENCE
MOSS BEACH, CA 94038
037-118-100


Table with 3 columns: No., Description, Date. Includes PRELIMINARY DESIGN and REVISED PLAN.

DEWETT RESIDENCE
1 STORY HOME
Title Sheet
Project number
Date: 2017.04.12
Drawn by: ECS
Checked by: CF
Scale: As indicated



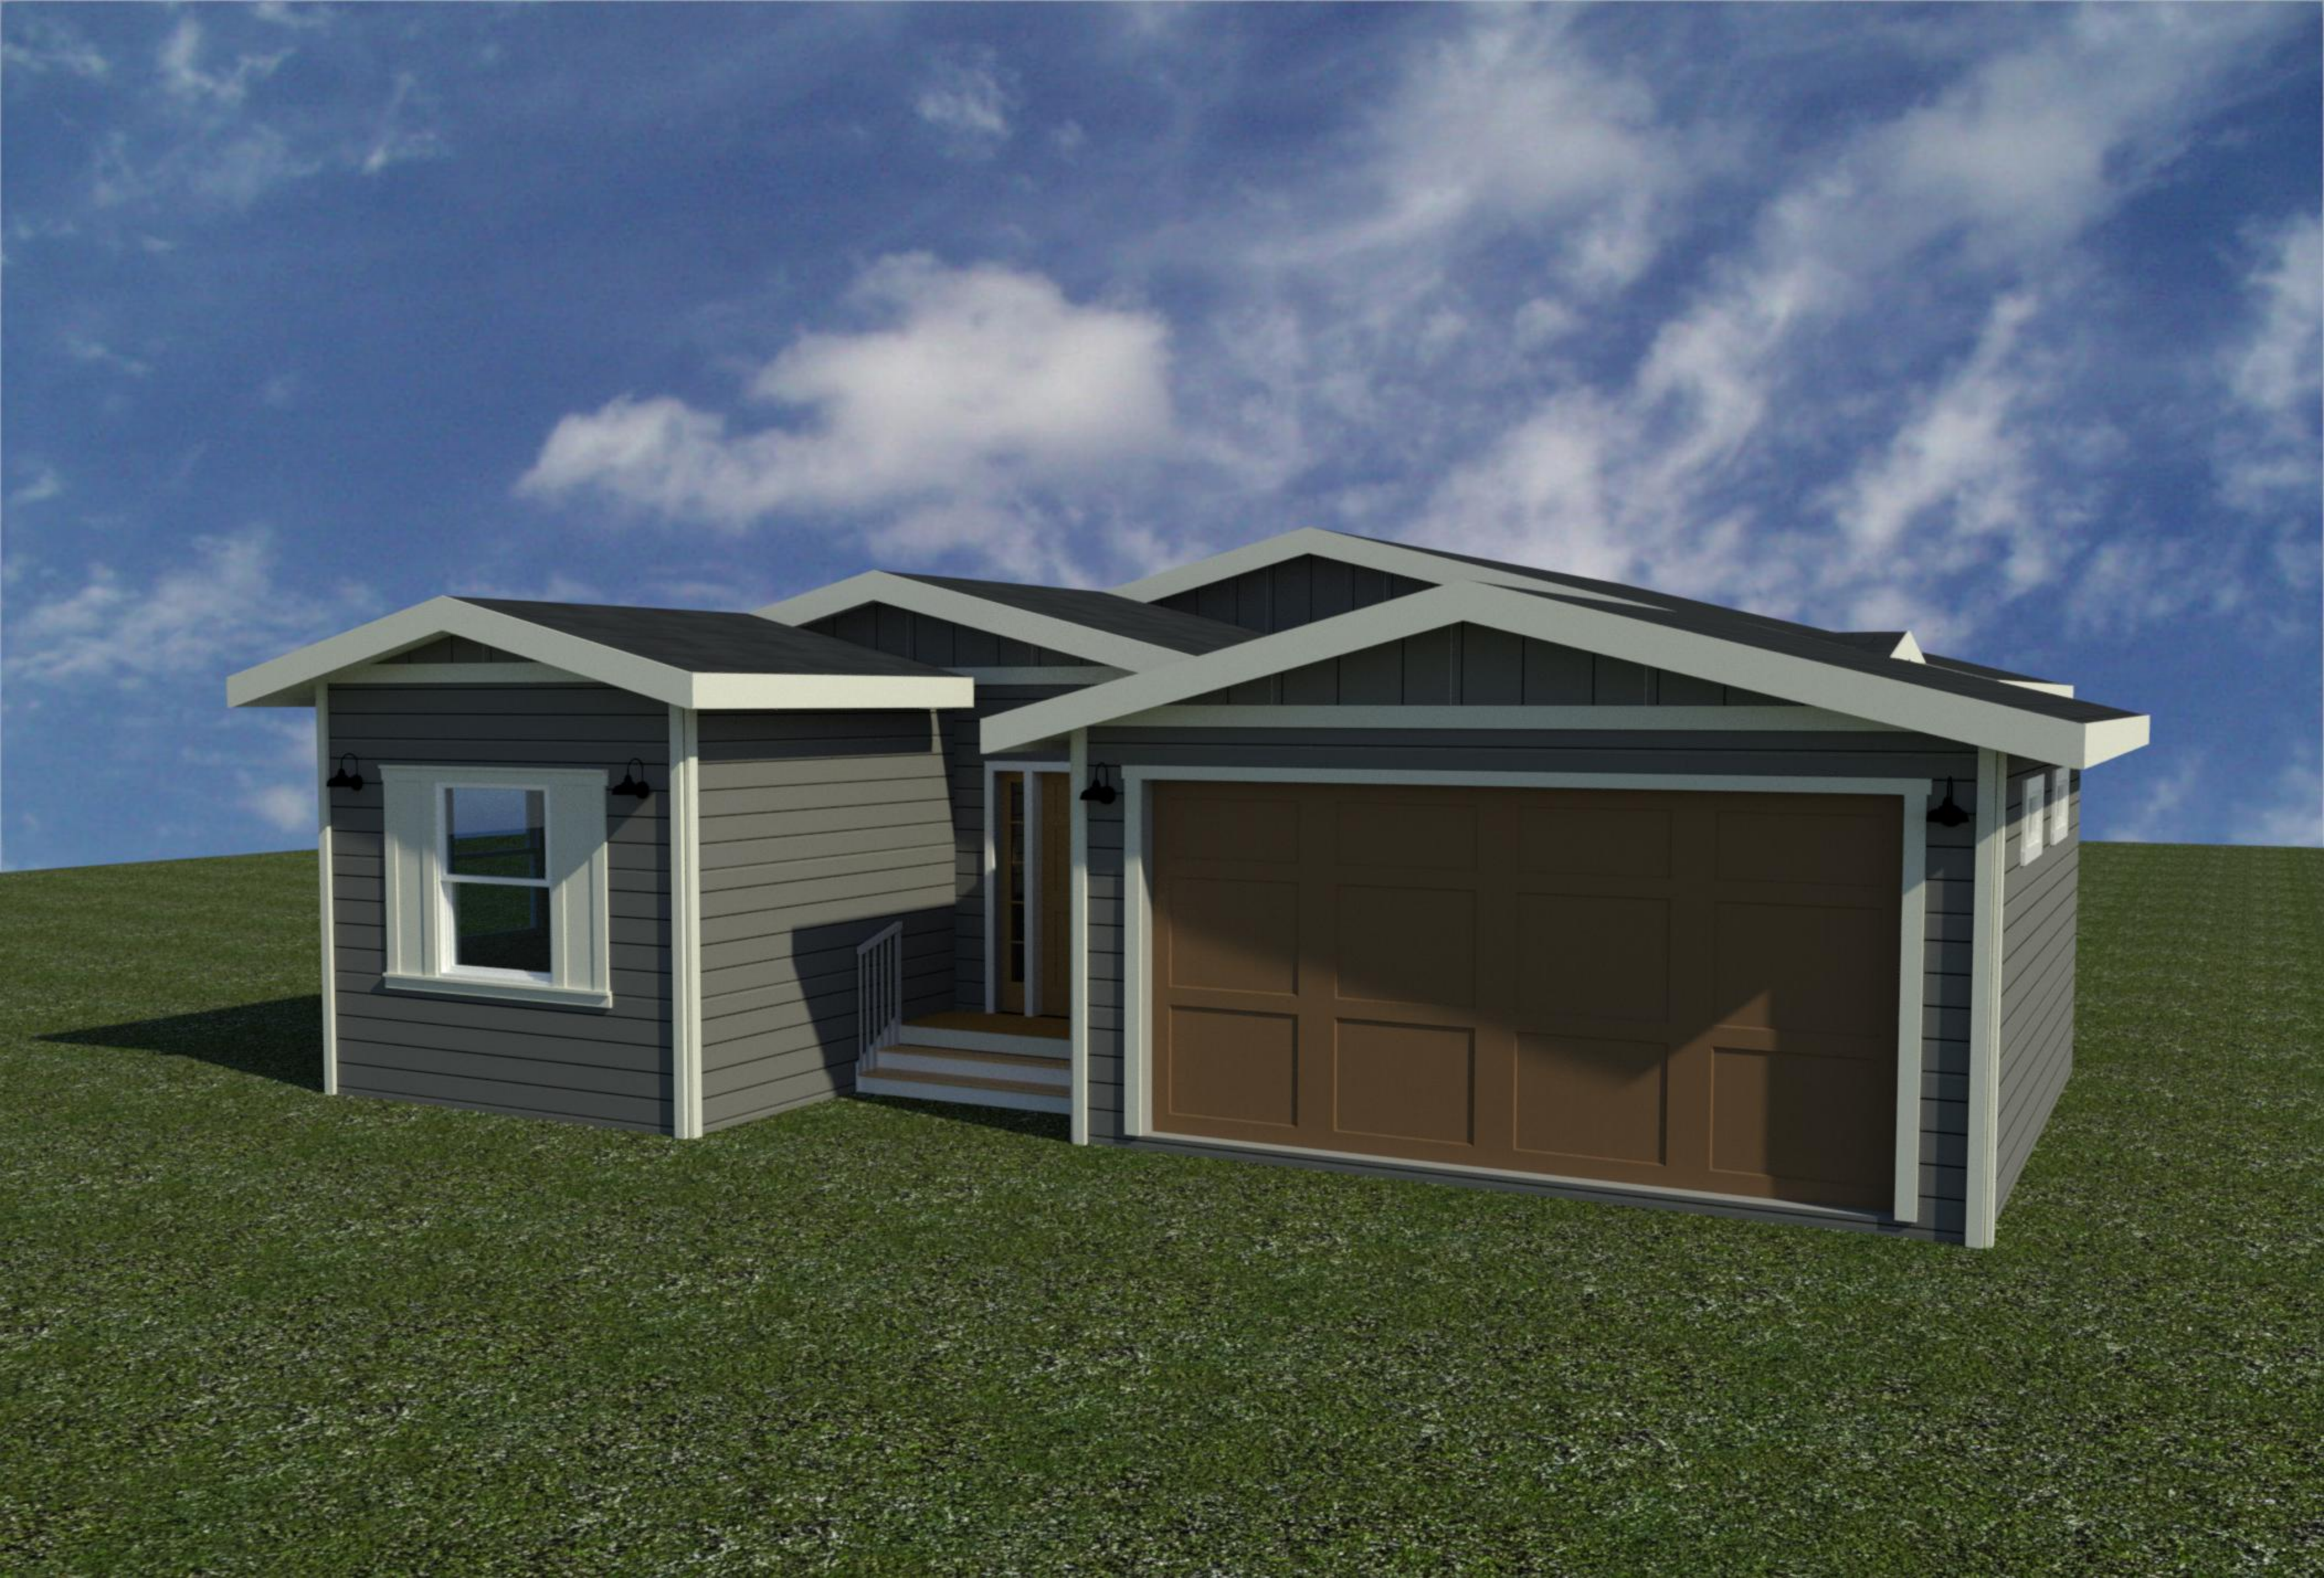

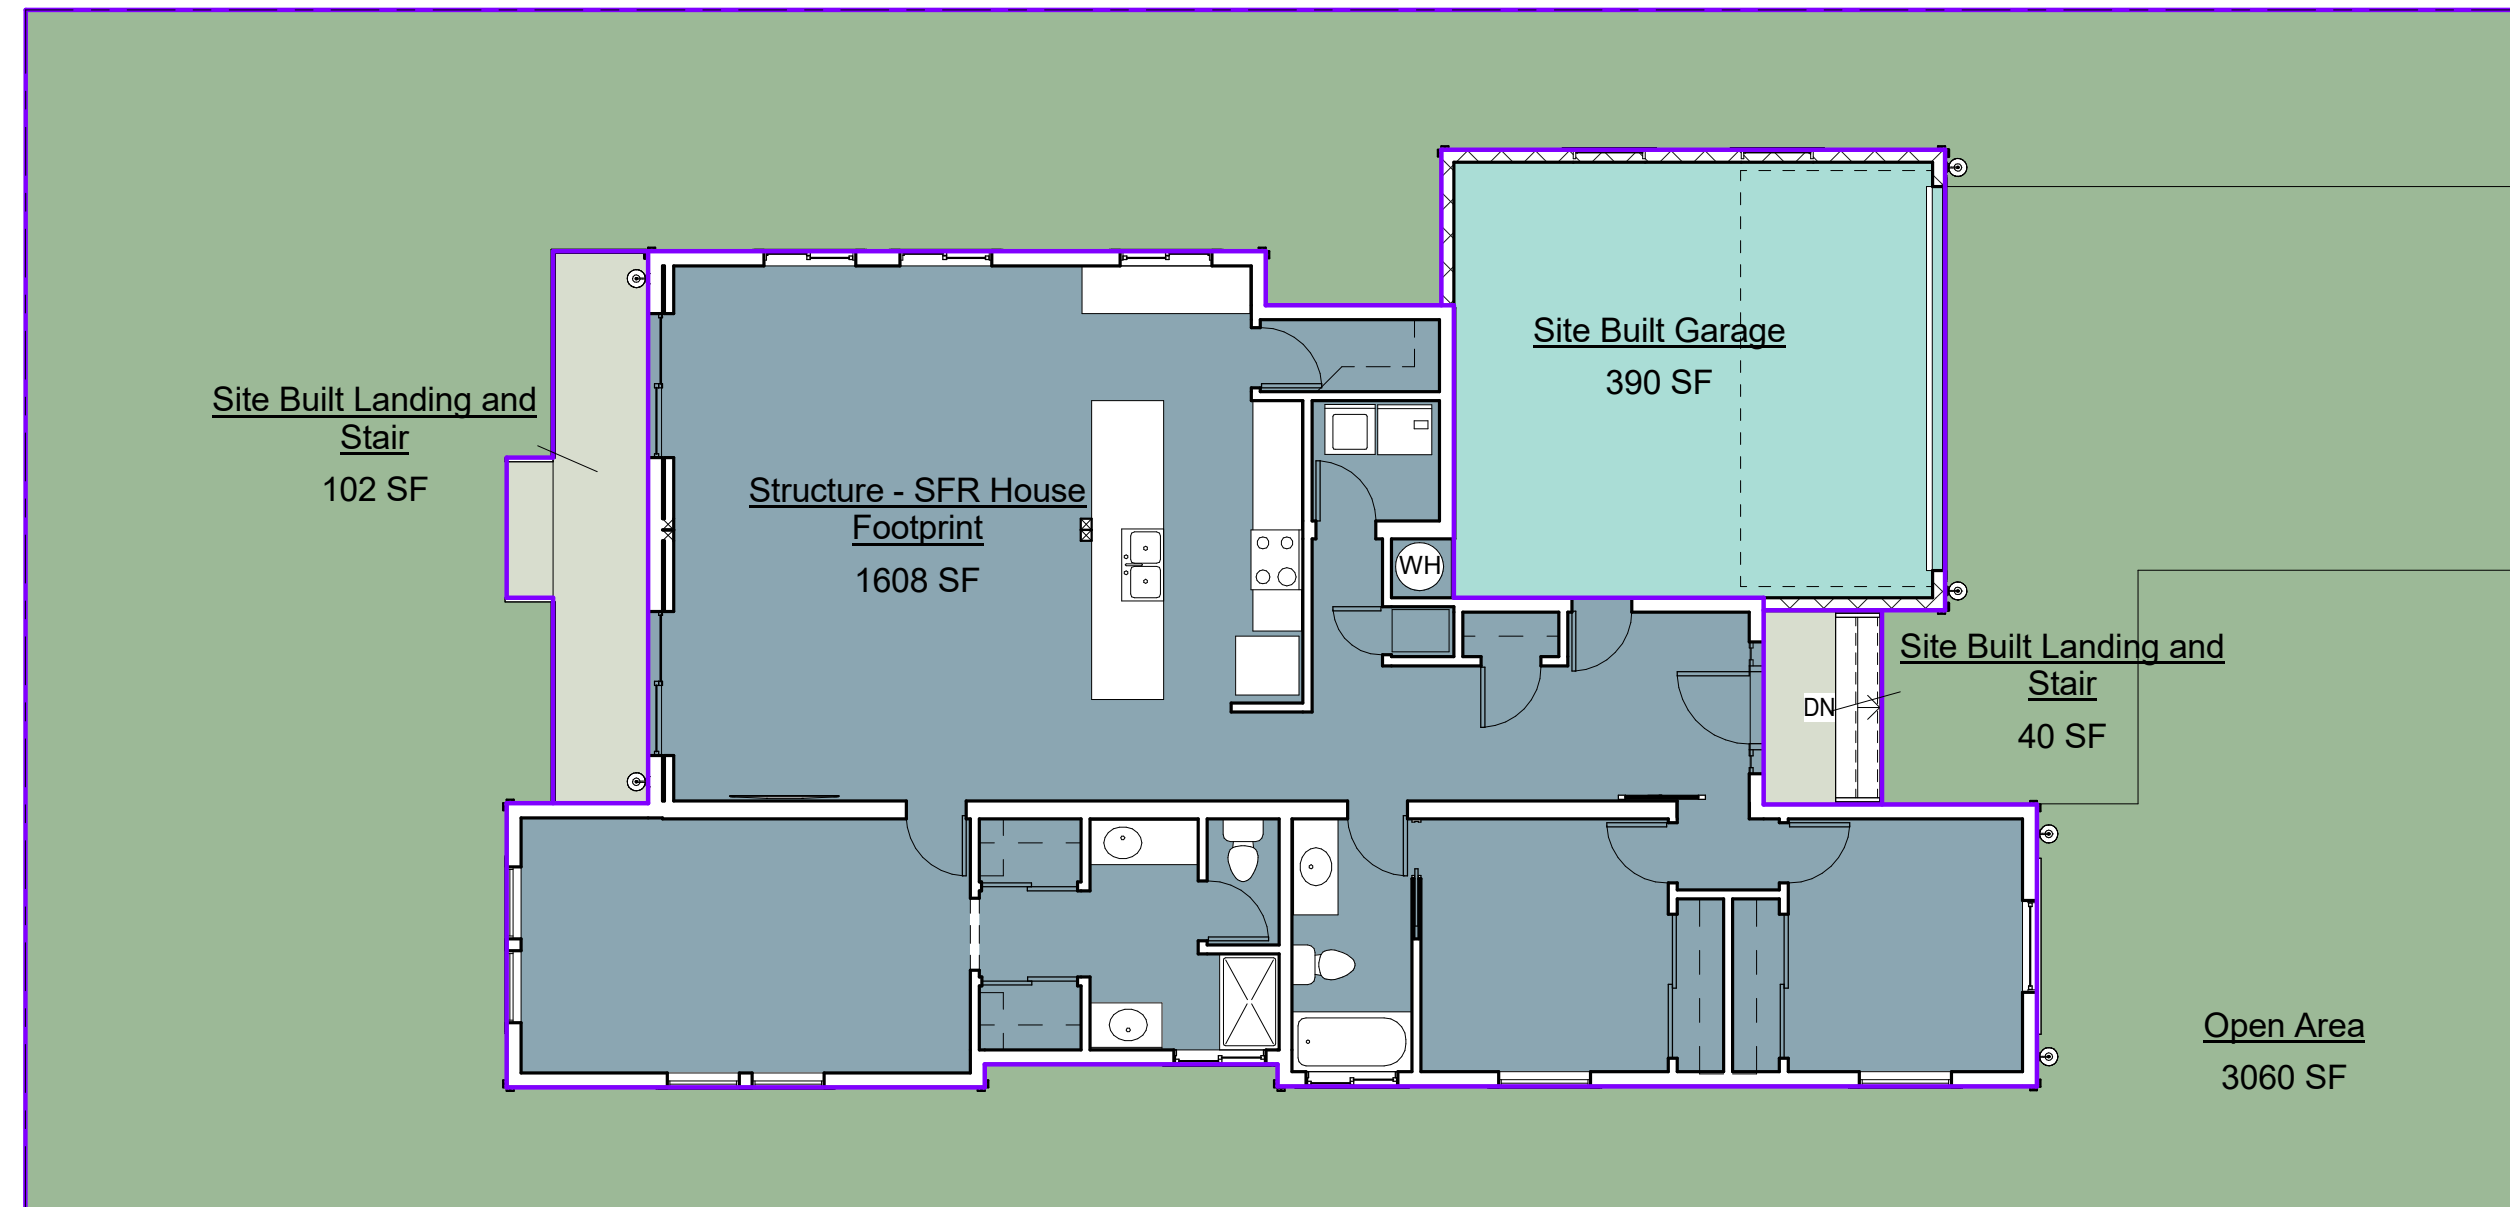① Areas
1/8" = 1'-0"

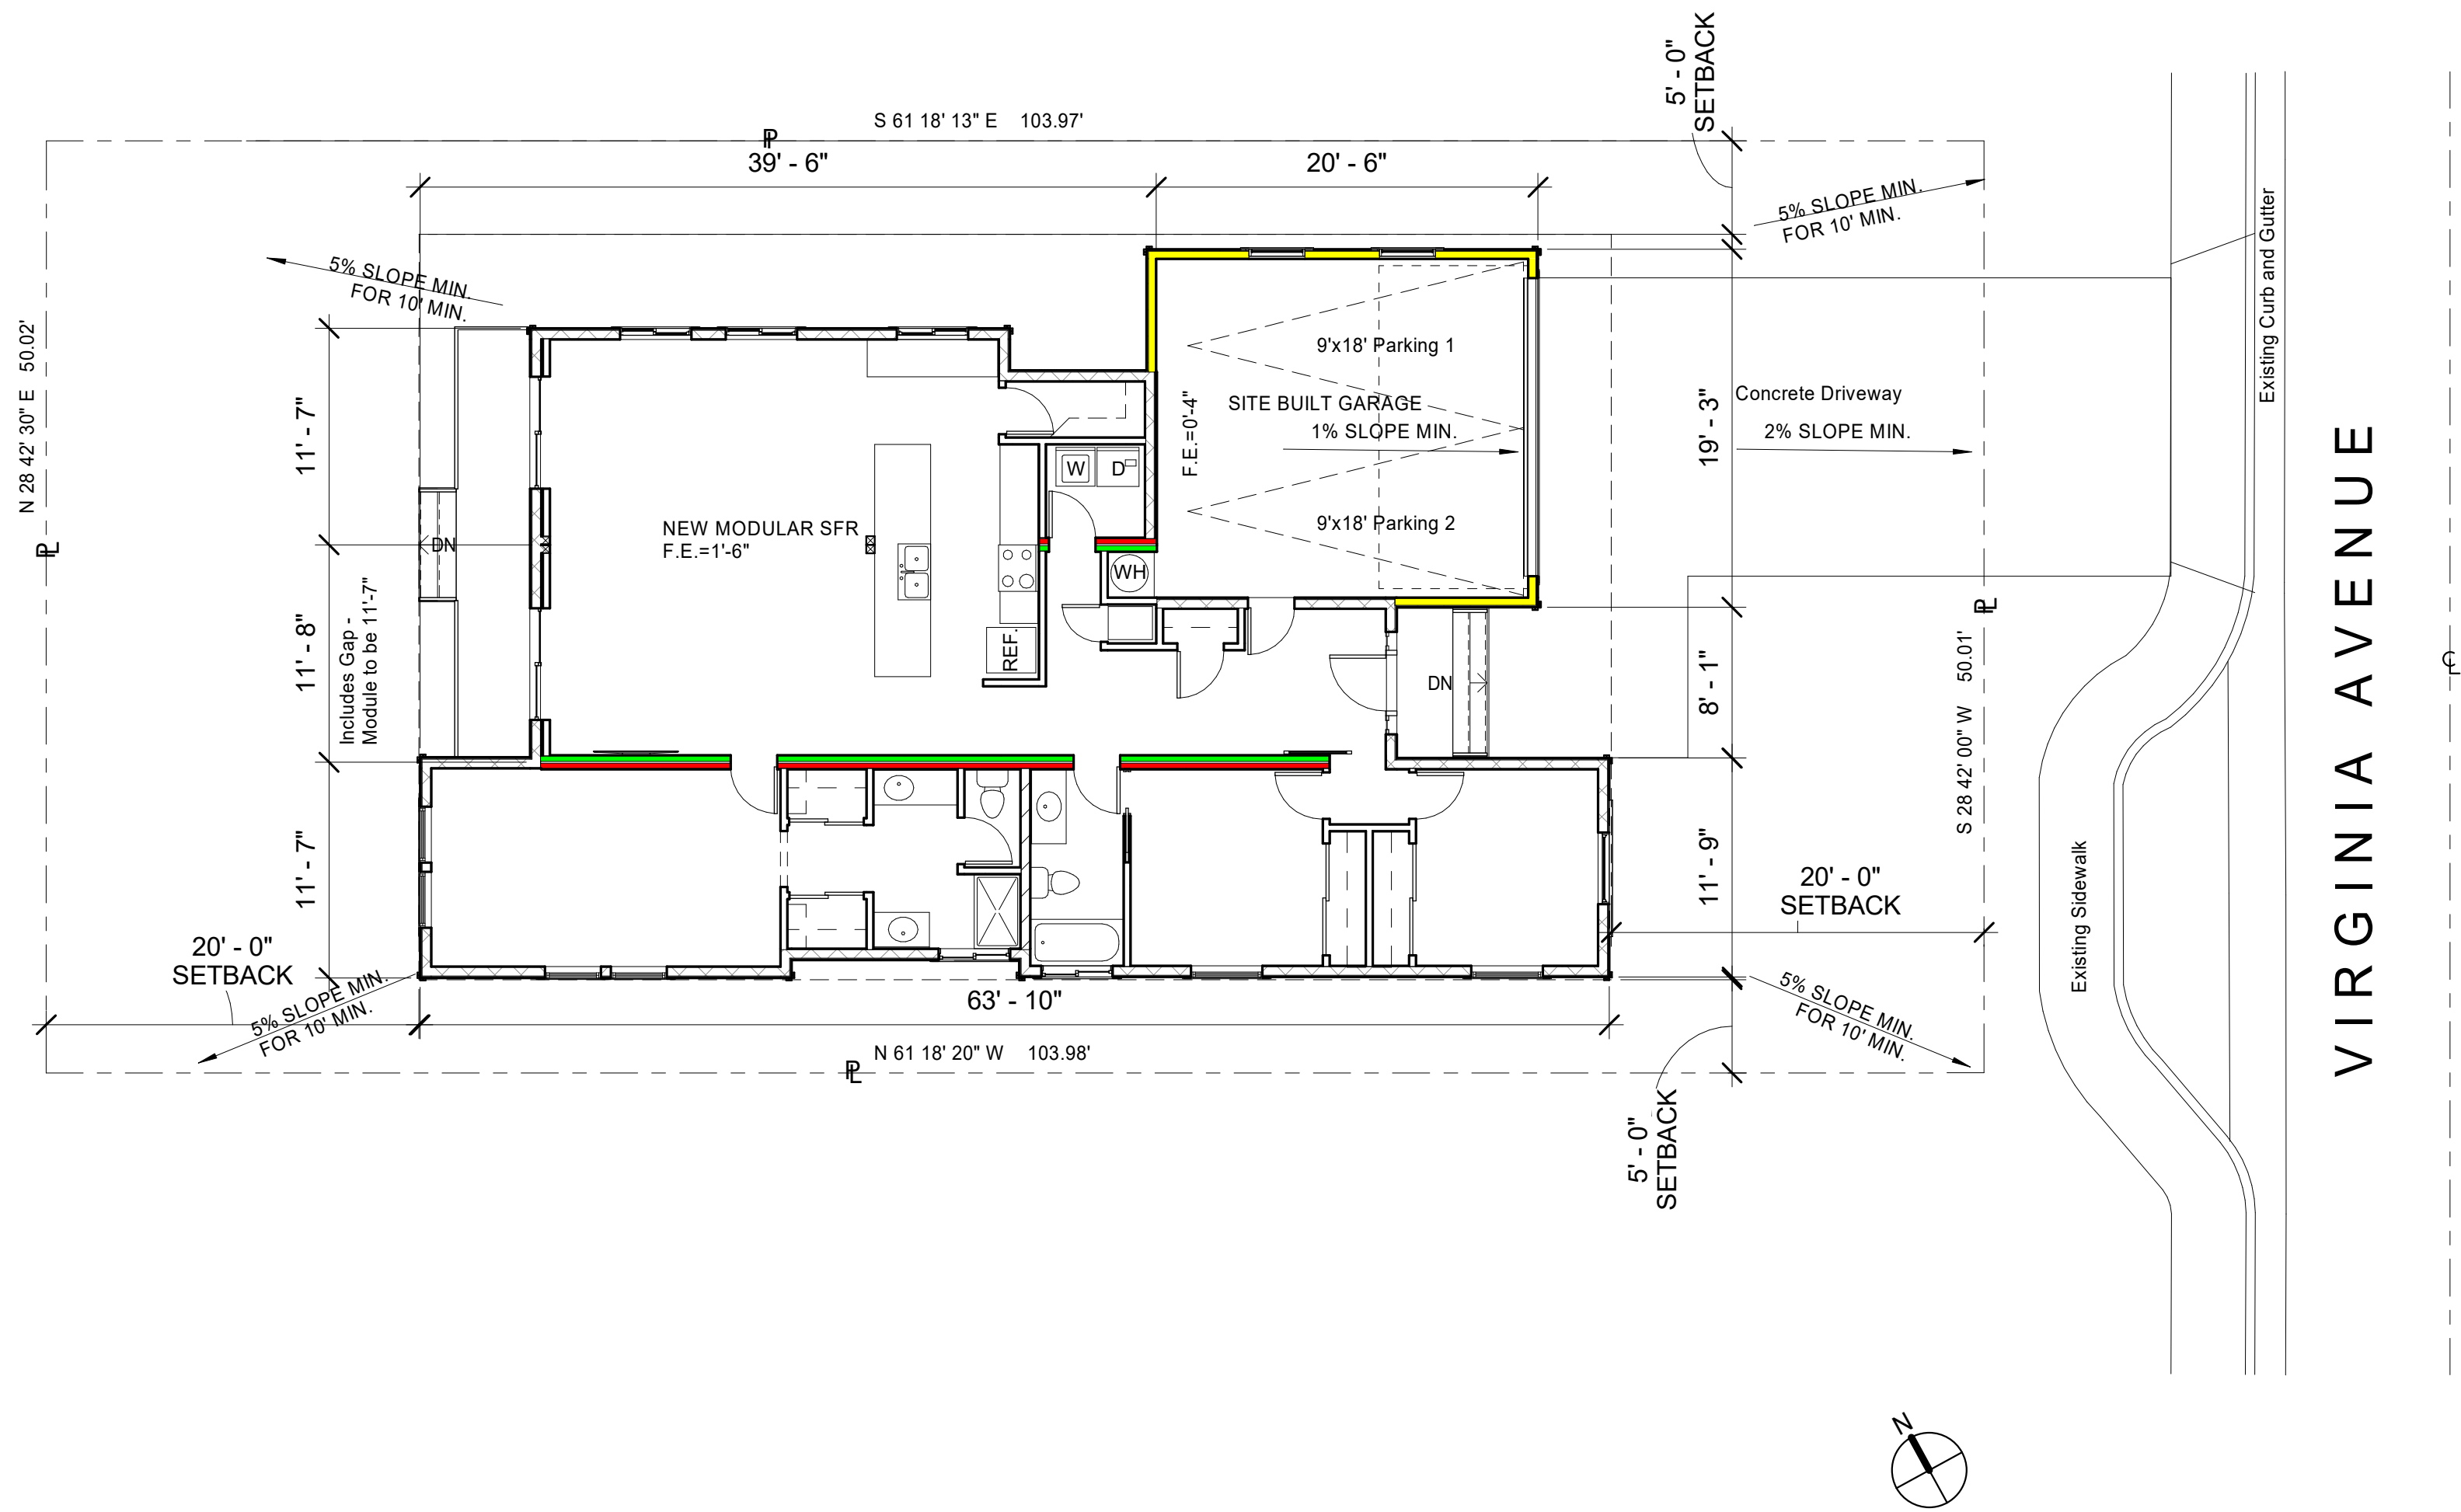

② Site Plan Copy 1
1/8" = 1'-0"



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DEWETT RESIDENCE

MOSS BEACH, CA 94038

037-118-100

No.	Description	Date
A	PRELIMINARY DESIGN	2017.04.12
B	REVISED PLAN	

DEWETT RESIDENCE

1 STORY HOME

Site Plan


Project number	
Date	2017.04.12
Drawn by	ECS
Checked by	Checker

A1

Scale 1/8" = 1'-0"

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DEWETT RESIDENCE
MOSS BEACH, CA 94038
037-118-100

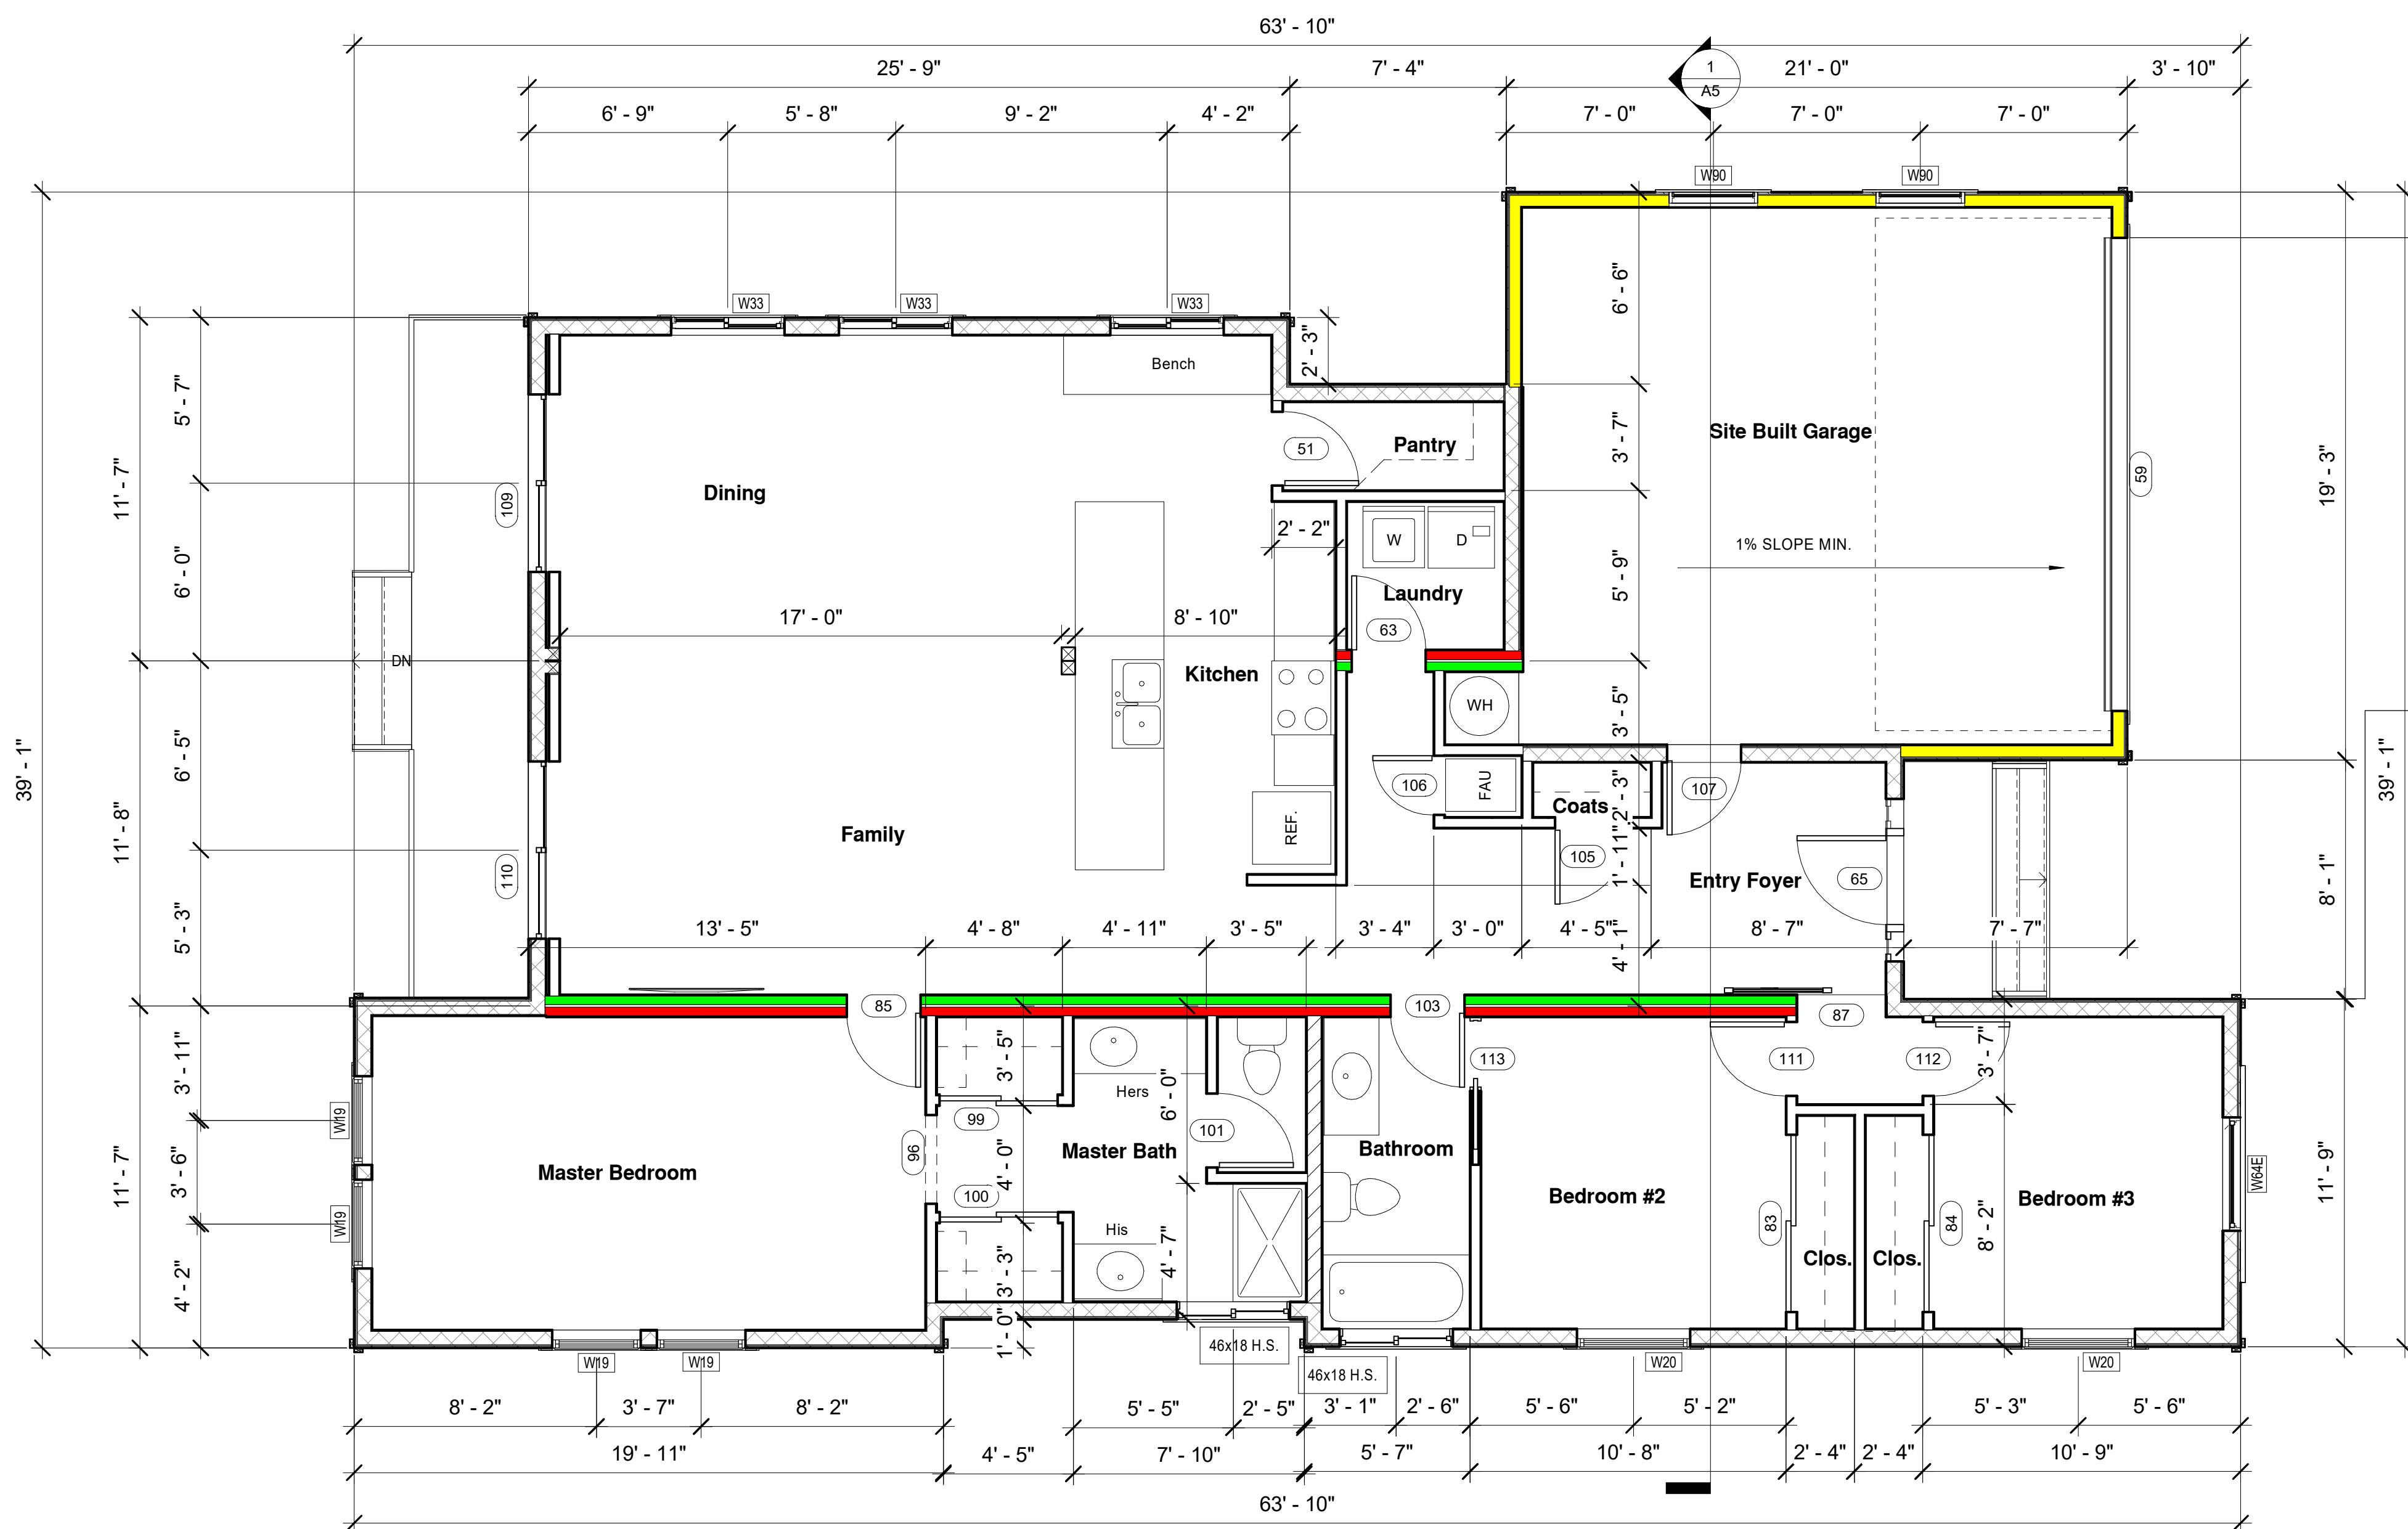

① First Floor
 1/4" = 1'-0"

WALL LEGEND

	MODULAR 2 X 6 EXTERIOR WALL
	SITE BUILT 2 X 6 WALL
	MODULAR 2 X 6 PLUMBING WALL
	STRUCTURAL INTERIOR WALL
	MODULAR NON STRUCTURAL INTERIOR WALL
	HALF WALL INTERIOR
	RAILING


No.	Description	Date
A	PRELIMINARY DESIGN	2017.04.12
B	REVISED PLAN	

DEWETT RESIDENCE
1 STORY HOME
Floor Plans

Project number _____
 Date 2017.04.12
 Drawn by ECS
 Checked by CFW

A2

Scale 1/4" = 1'-0"

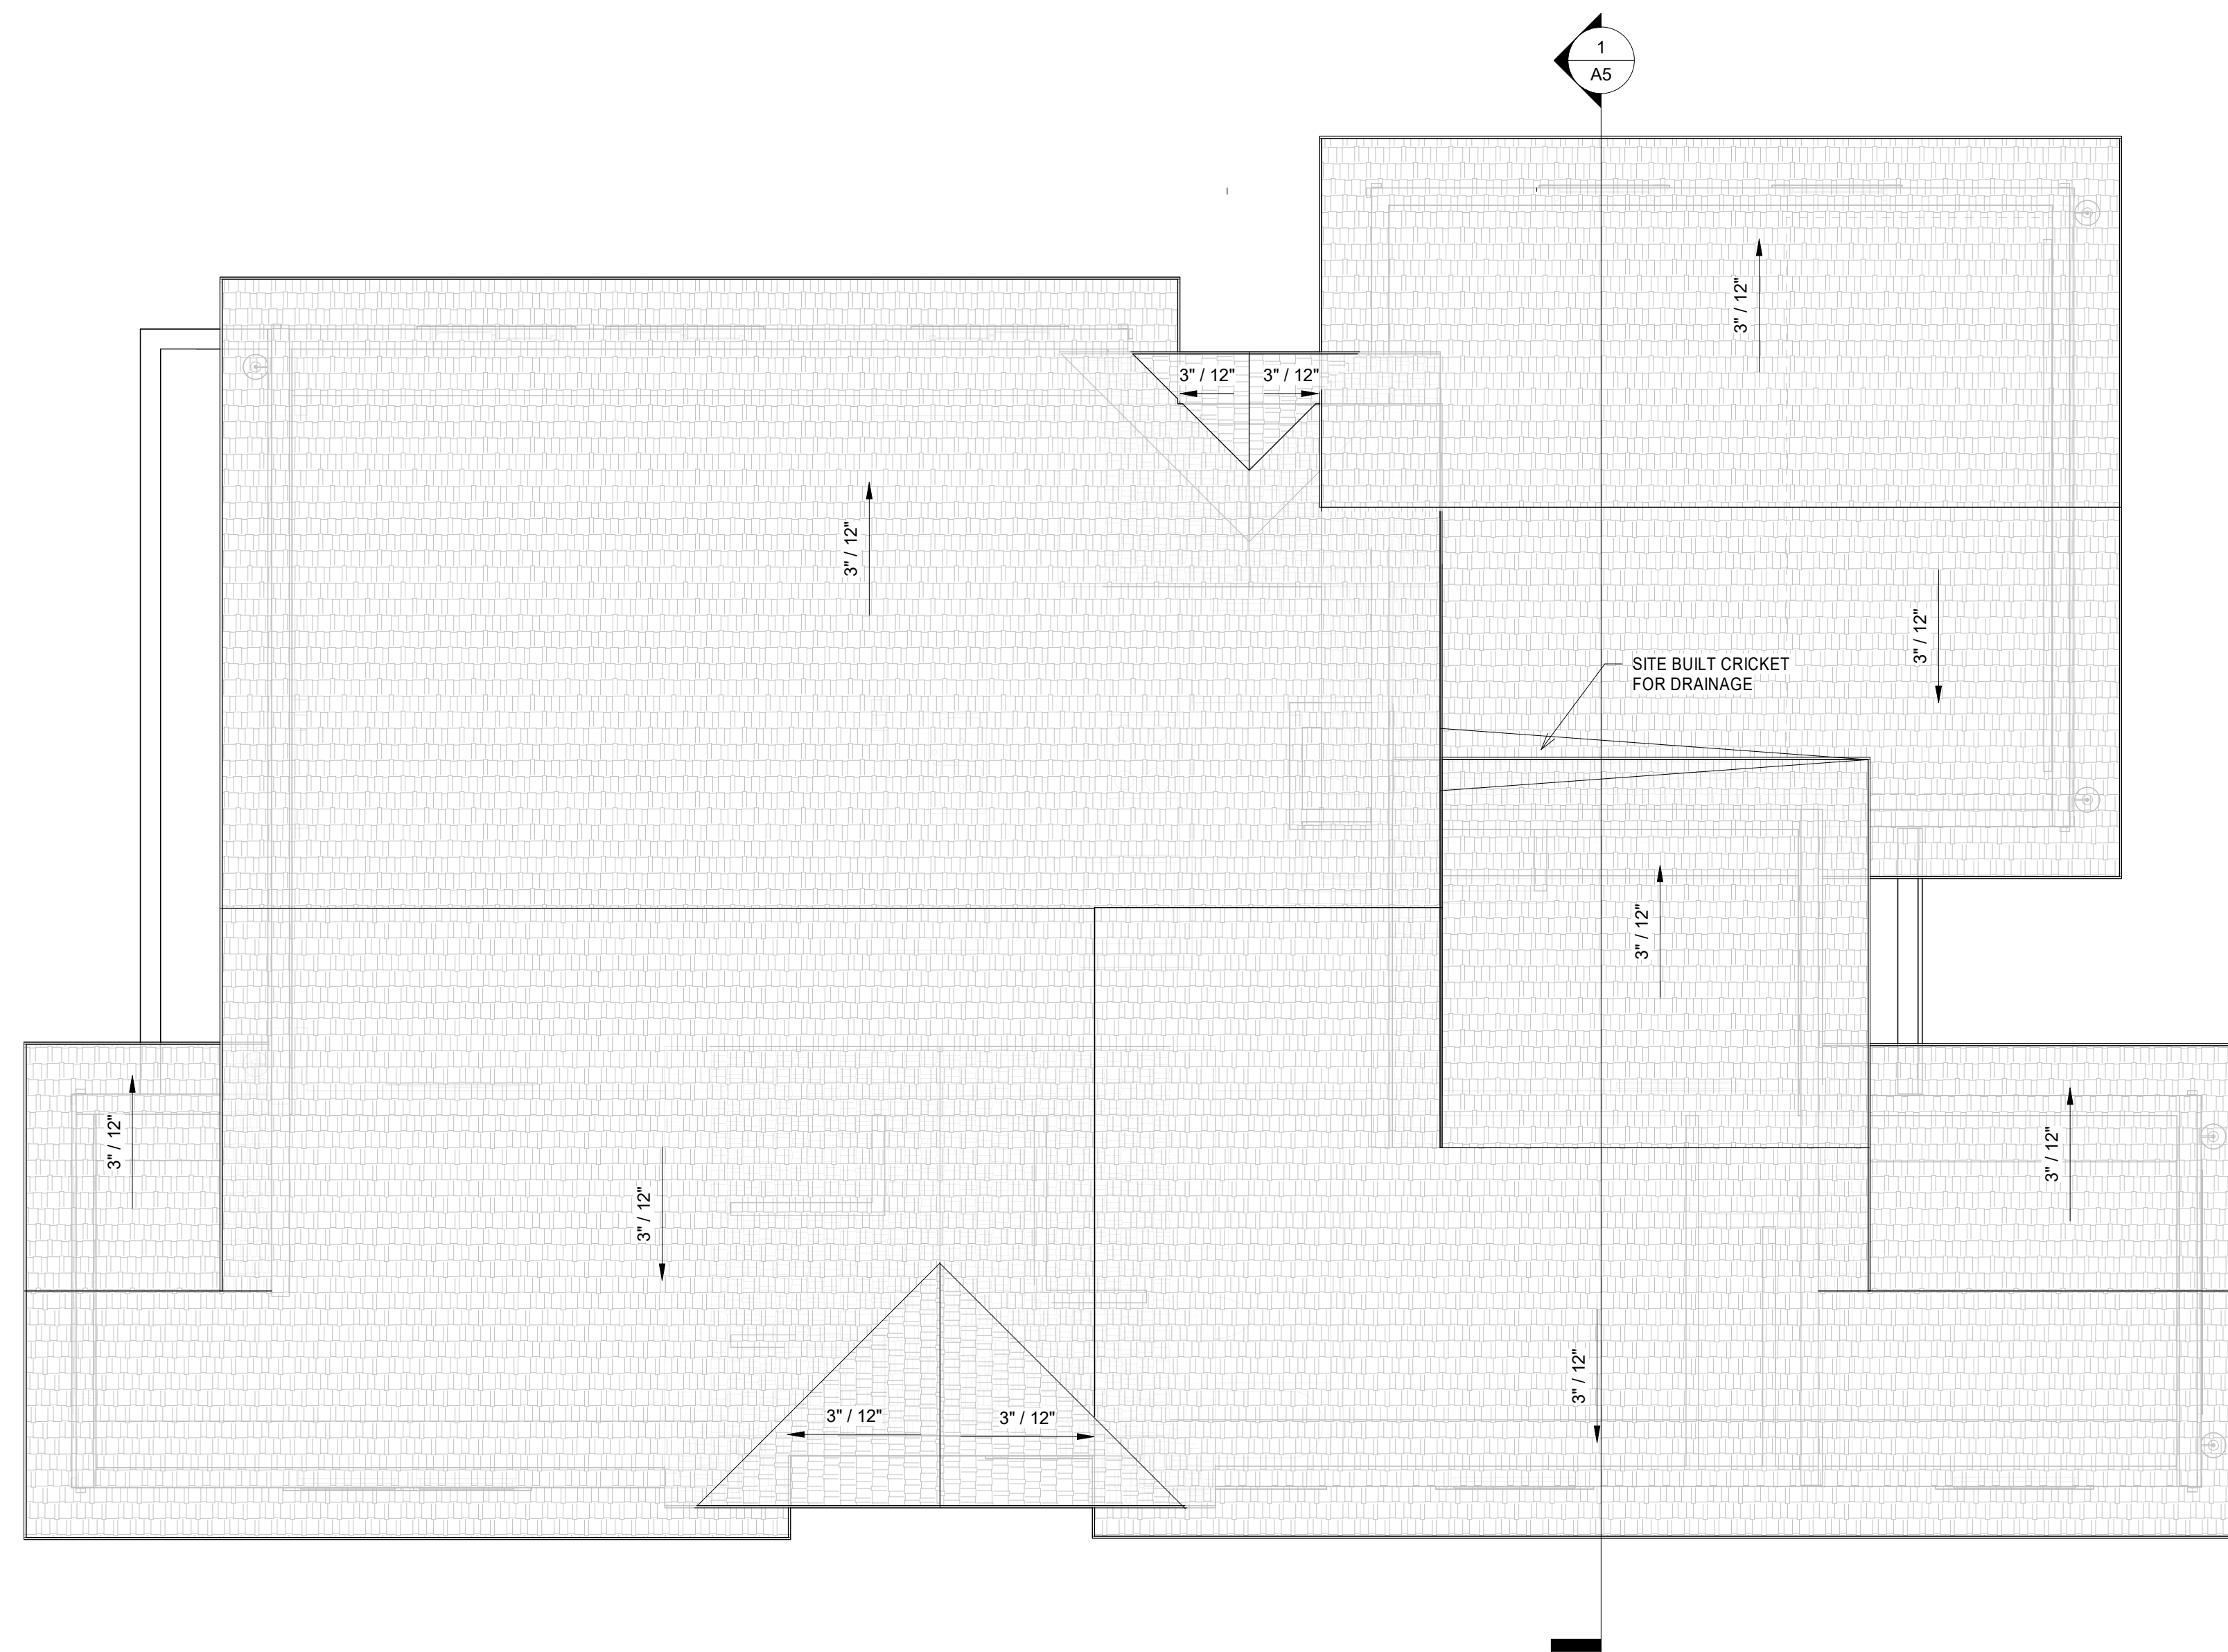

① Roof Plan
1/4" = 1'-0"

- **OVERHANG FOR ROOF IS 1'-6"**
- **ROOF PITCH IS 3/12**
- **18" SIDEWALL EAVES SHIPPED LOOSE AND INSTALLED ON-SITE BY OTHERS**



THESE CONSTRUCTION DOCUMENTS CREATED BY CUTTING EDGE HOMES ARE AN INSTRUMENT OF SERVICE PROVIDED TO THE OWNER BY THE DESIGNER. THESE DOCUMENTS ARE OWNED BY THE DESIGNER AND COPIES FOR APPROPRIATE PERMITS AND CONSTRUCTION SHALL BE PROVIDED TO THE OWNER. THESE DOCUMENTS SHALL NOT BE USED FOR ANY PROJECT OTHER THAN THE SPECIFIC PROJECT CONTRACT FOR. NO EXCEPTIONS.

DEWETT RESIDENCE
MOSS BEACH, CA 94038
037-118-100

No.	Description	Date
A	PRELIMINARY DESIGN	2017.04.12
B	REVISED PLAN	

DEWETT RESIDENCE
1 STORY HOME
Roof Plan


Project number _____
Date 2017.04.12
Drawn by ECS
Checked by _____ Checker

A3

Scale 1/4" = 1'-0"

THESE CONSTRUCTION DOCUMENTS CREATED BY CUTTING EDGE HOMES ARE AN INSTRUMENT OF SERVICE PROVIDED TO THE OWNER BY THE DESIGNER. THESE DOCUMENTS ARE OWNED BY THE DESIGNER AND COPIES FOR APPROPRIATE PERMITS AND CONSTRUCTION SHALL BE PROVIDED TO THE OWNER. THESE DOCUMENTS SHALL NOT BE USED FOR ANY PROJECT OTHER THAN THE SPECIFIC PROJECT CONTRACT FOR. NO EXCEPTIONS.


DEWETT RESIDENCE
MOSS BEACH, CA 94038
037-118-100

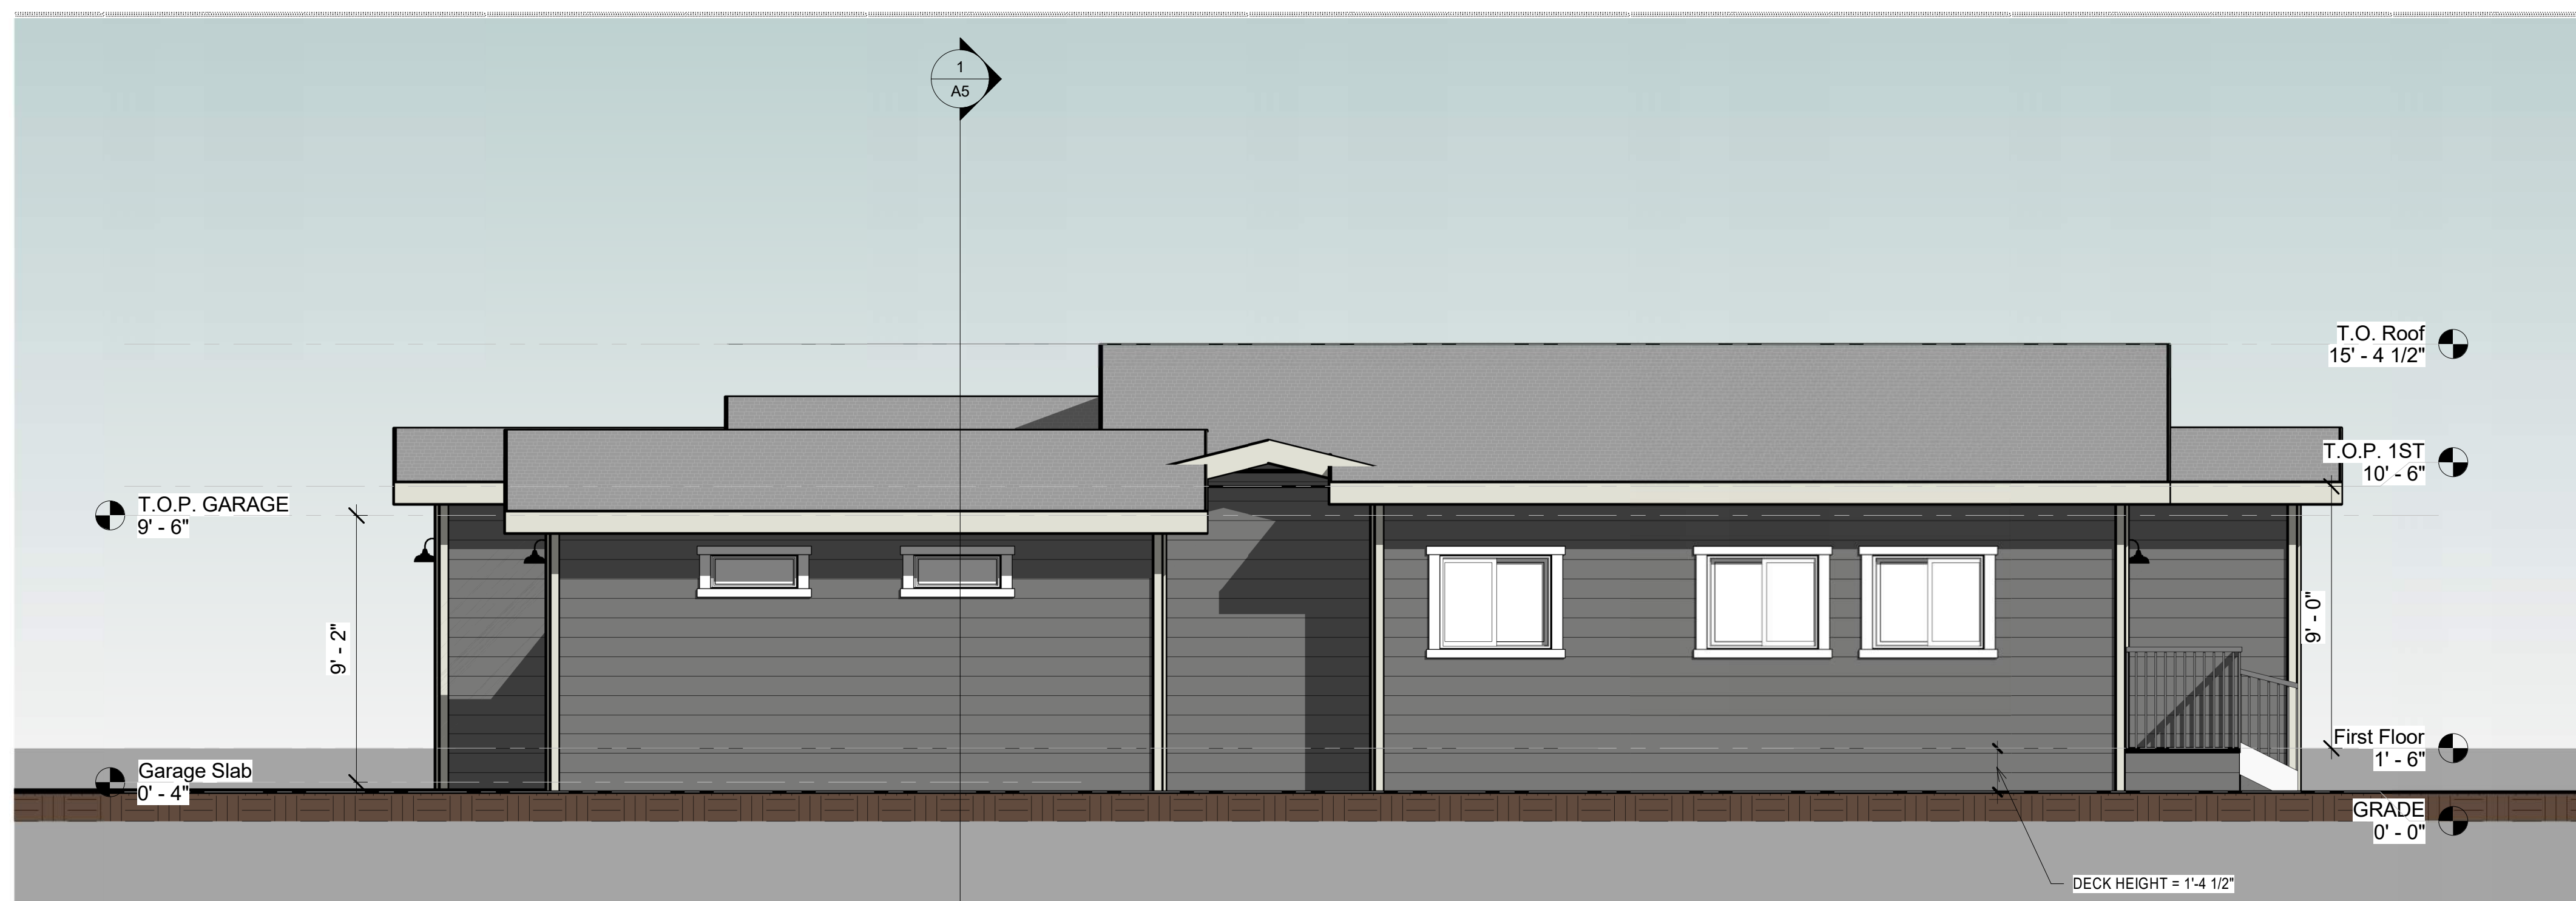

② Right Side Elevation
 1/4" = 1'-0"




NOTE:
 AS PER CODE, 18" CRAWL SPACE IS REQUIRED. FOUNDATION AND DRAINAGE BY OTHERS.

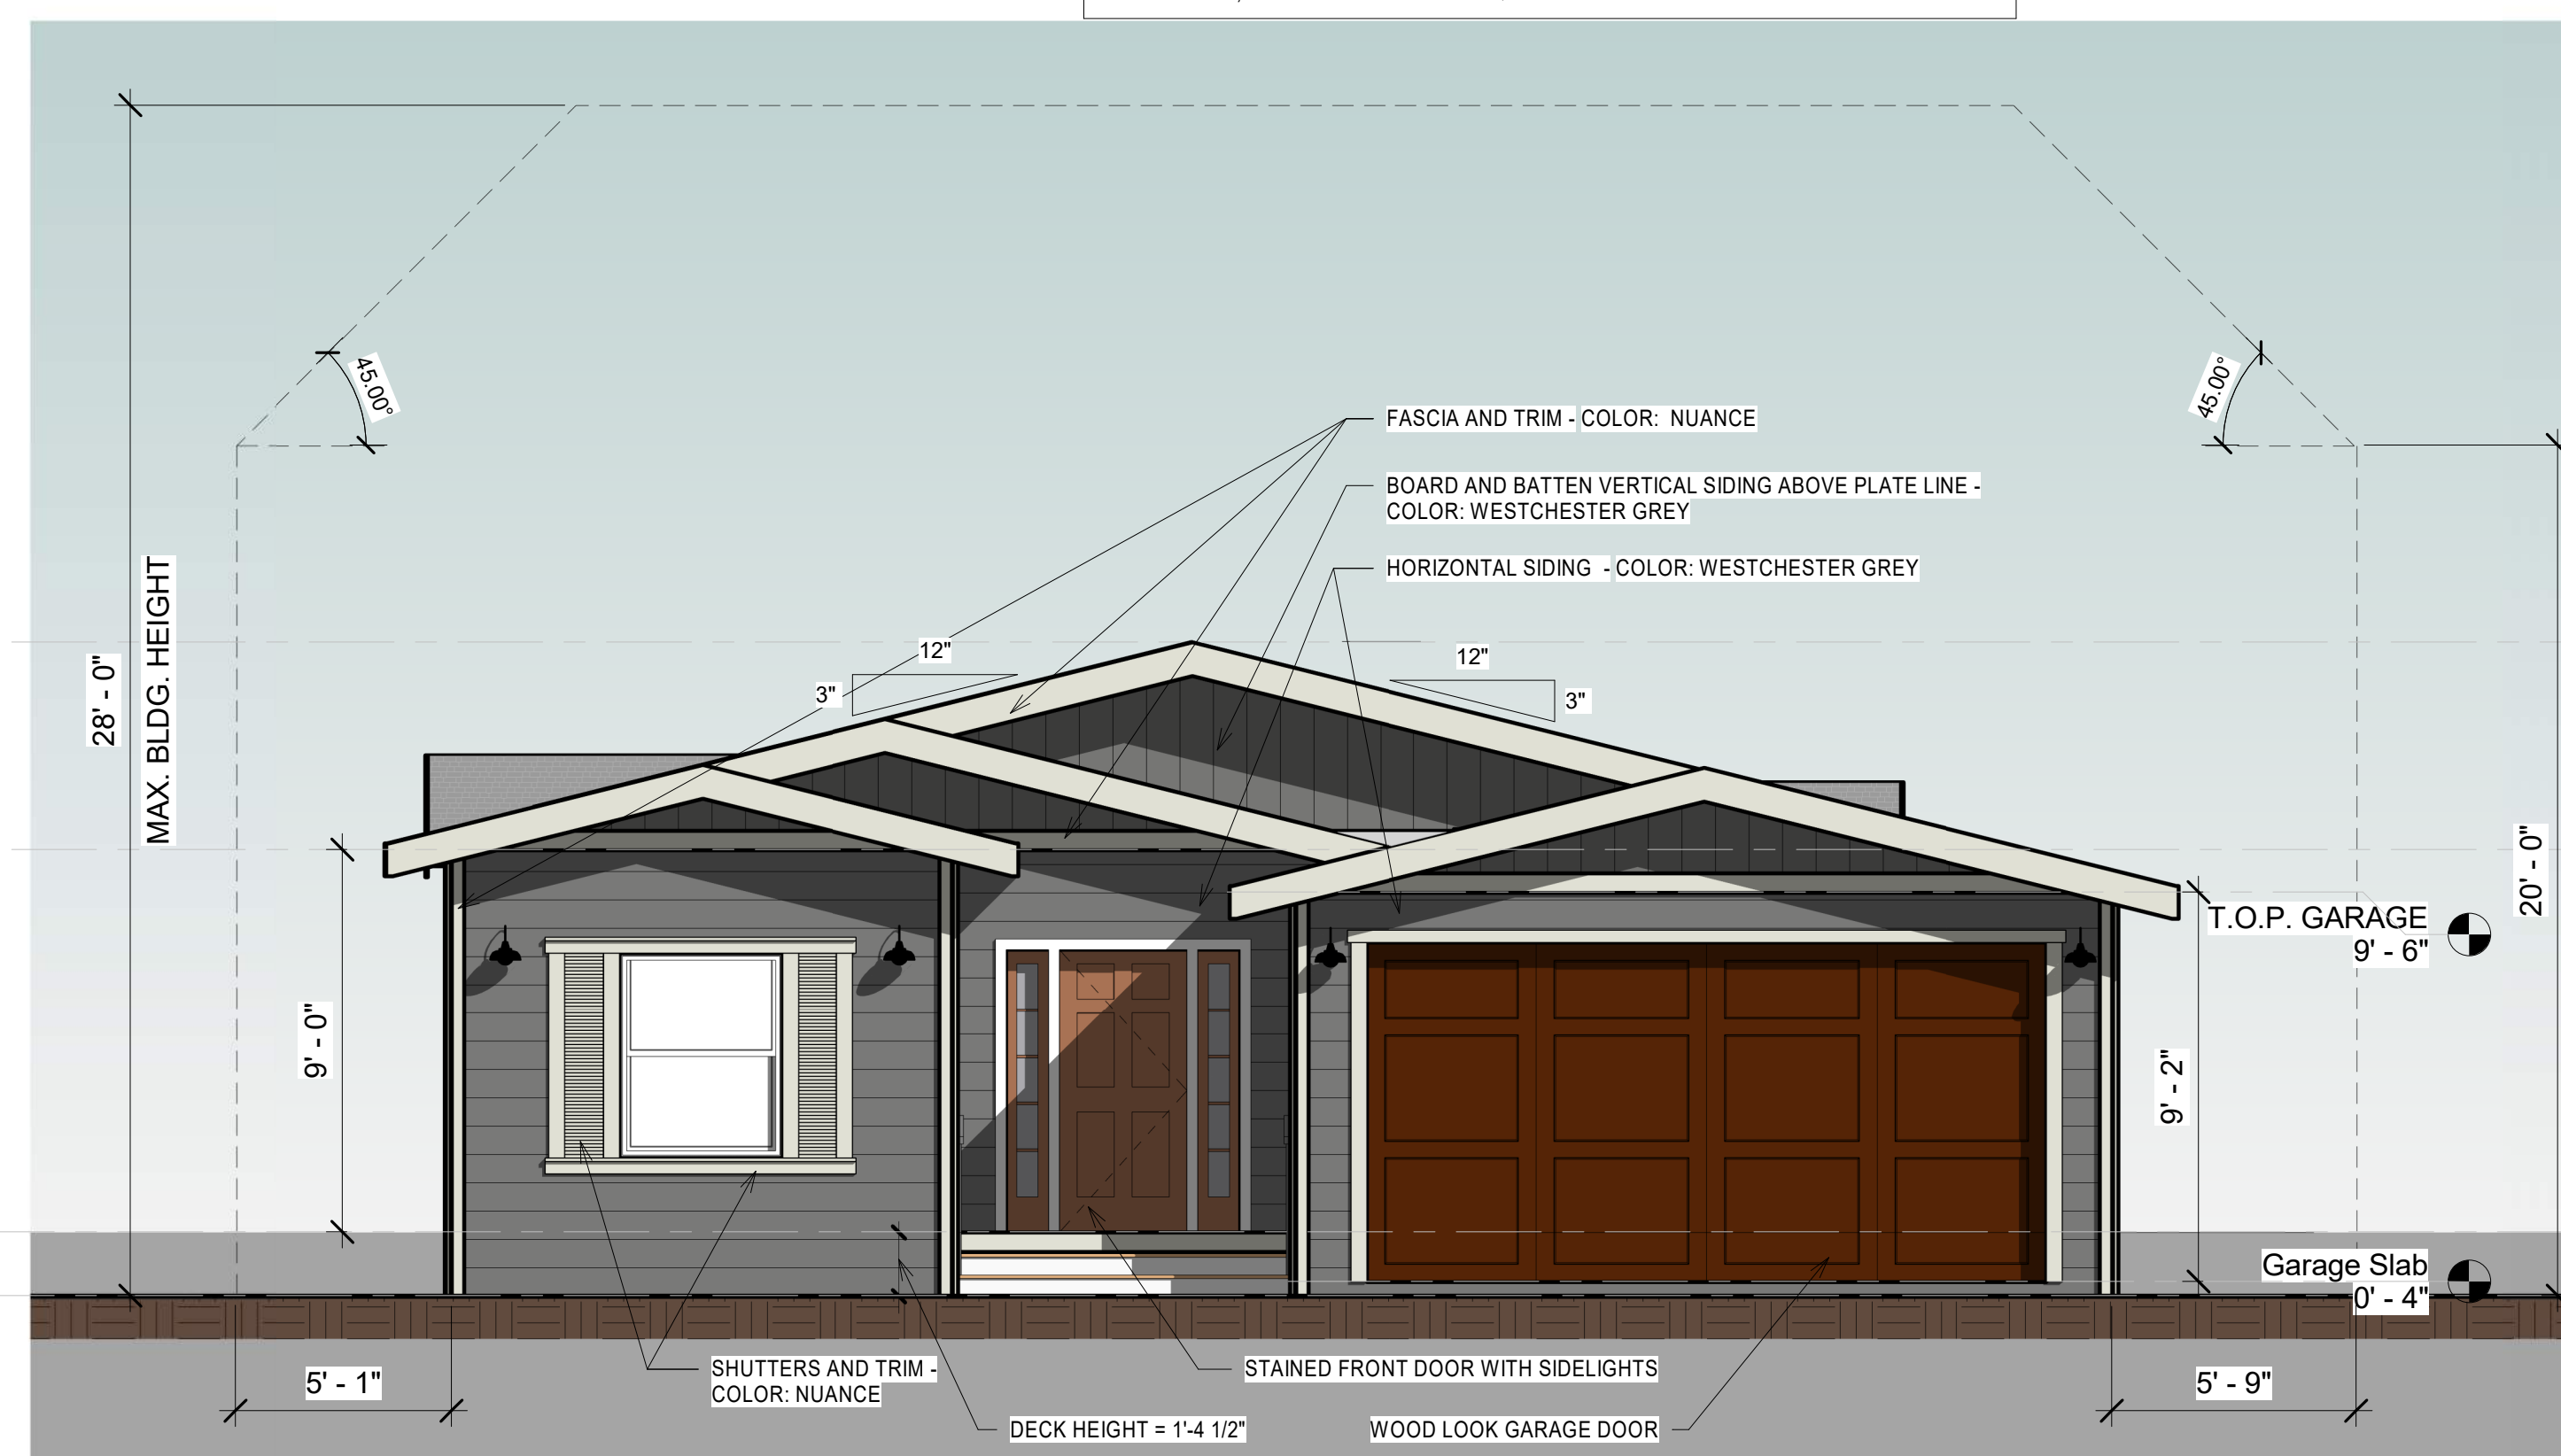PLANNING REQUIREMENTS:
 MAX. HEIGHT: 28'-0"
 MAX PARCEL COVERAGE: <16'-0" = 50%



① Front Elevation
 1/4" = 1'-0"

Materials Legend

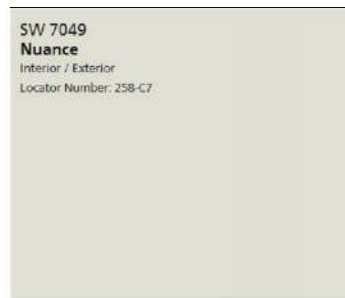-  Roofing: Owens Corning Supreme Shingle
 25-Year Class 'A'
 Color: Onyx Black
-  Exterior Siding: James Hardie CemPlank
 Fiber Cement Siding - Painted Sherwin
 Williams Exterior Paint.
 Color "Westchester Gray" SW2849
-  Window Trim and Fascia: Painted Sherwin
 Williams Exterior Paint.
 Color "Nuance" SW 7049

- **18" SIDEWALL EAVES SHIPPED LOOSE AND INSTALLED ON-SITE (BY OTHERS)**

- **18" ENDWALL EAVES FACTORY INSTALLED**

No.	Description	Date
A	PRELIMINARY DESIGN	2017.04.12
B	REVISED PLAN	

DEWETT RESIDENCE
1 STORY HOME
Front & Right side Elevations


Project number	
Date	2017.04.12
Drawn by	ECS
Checked by	CFW

A4

Scale 1/4" = 1'-0"

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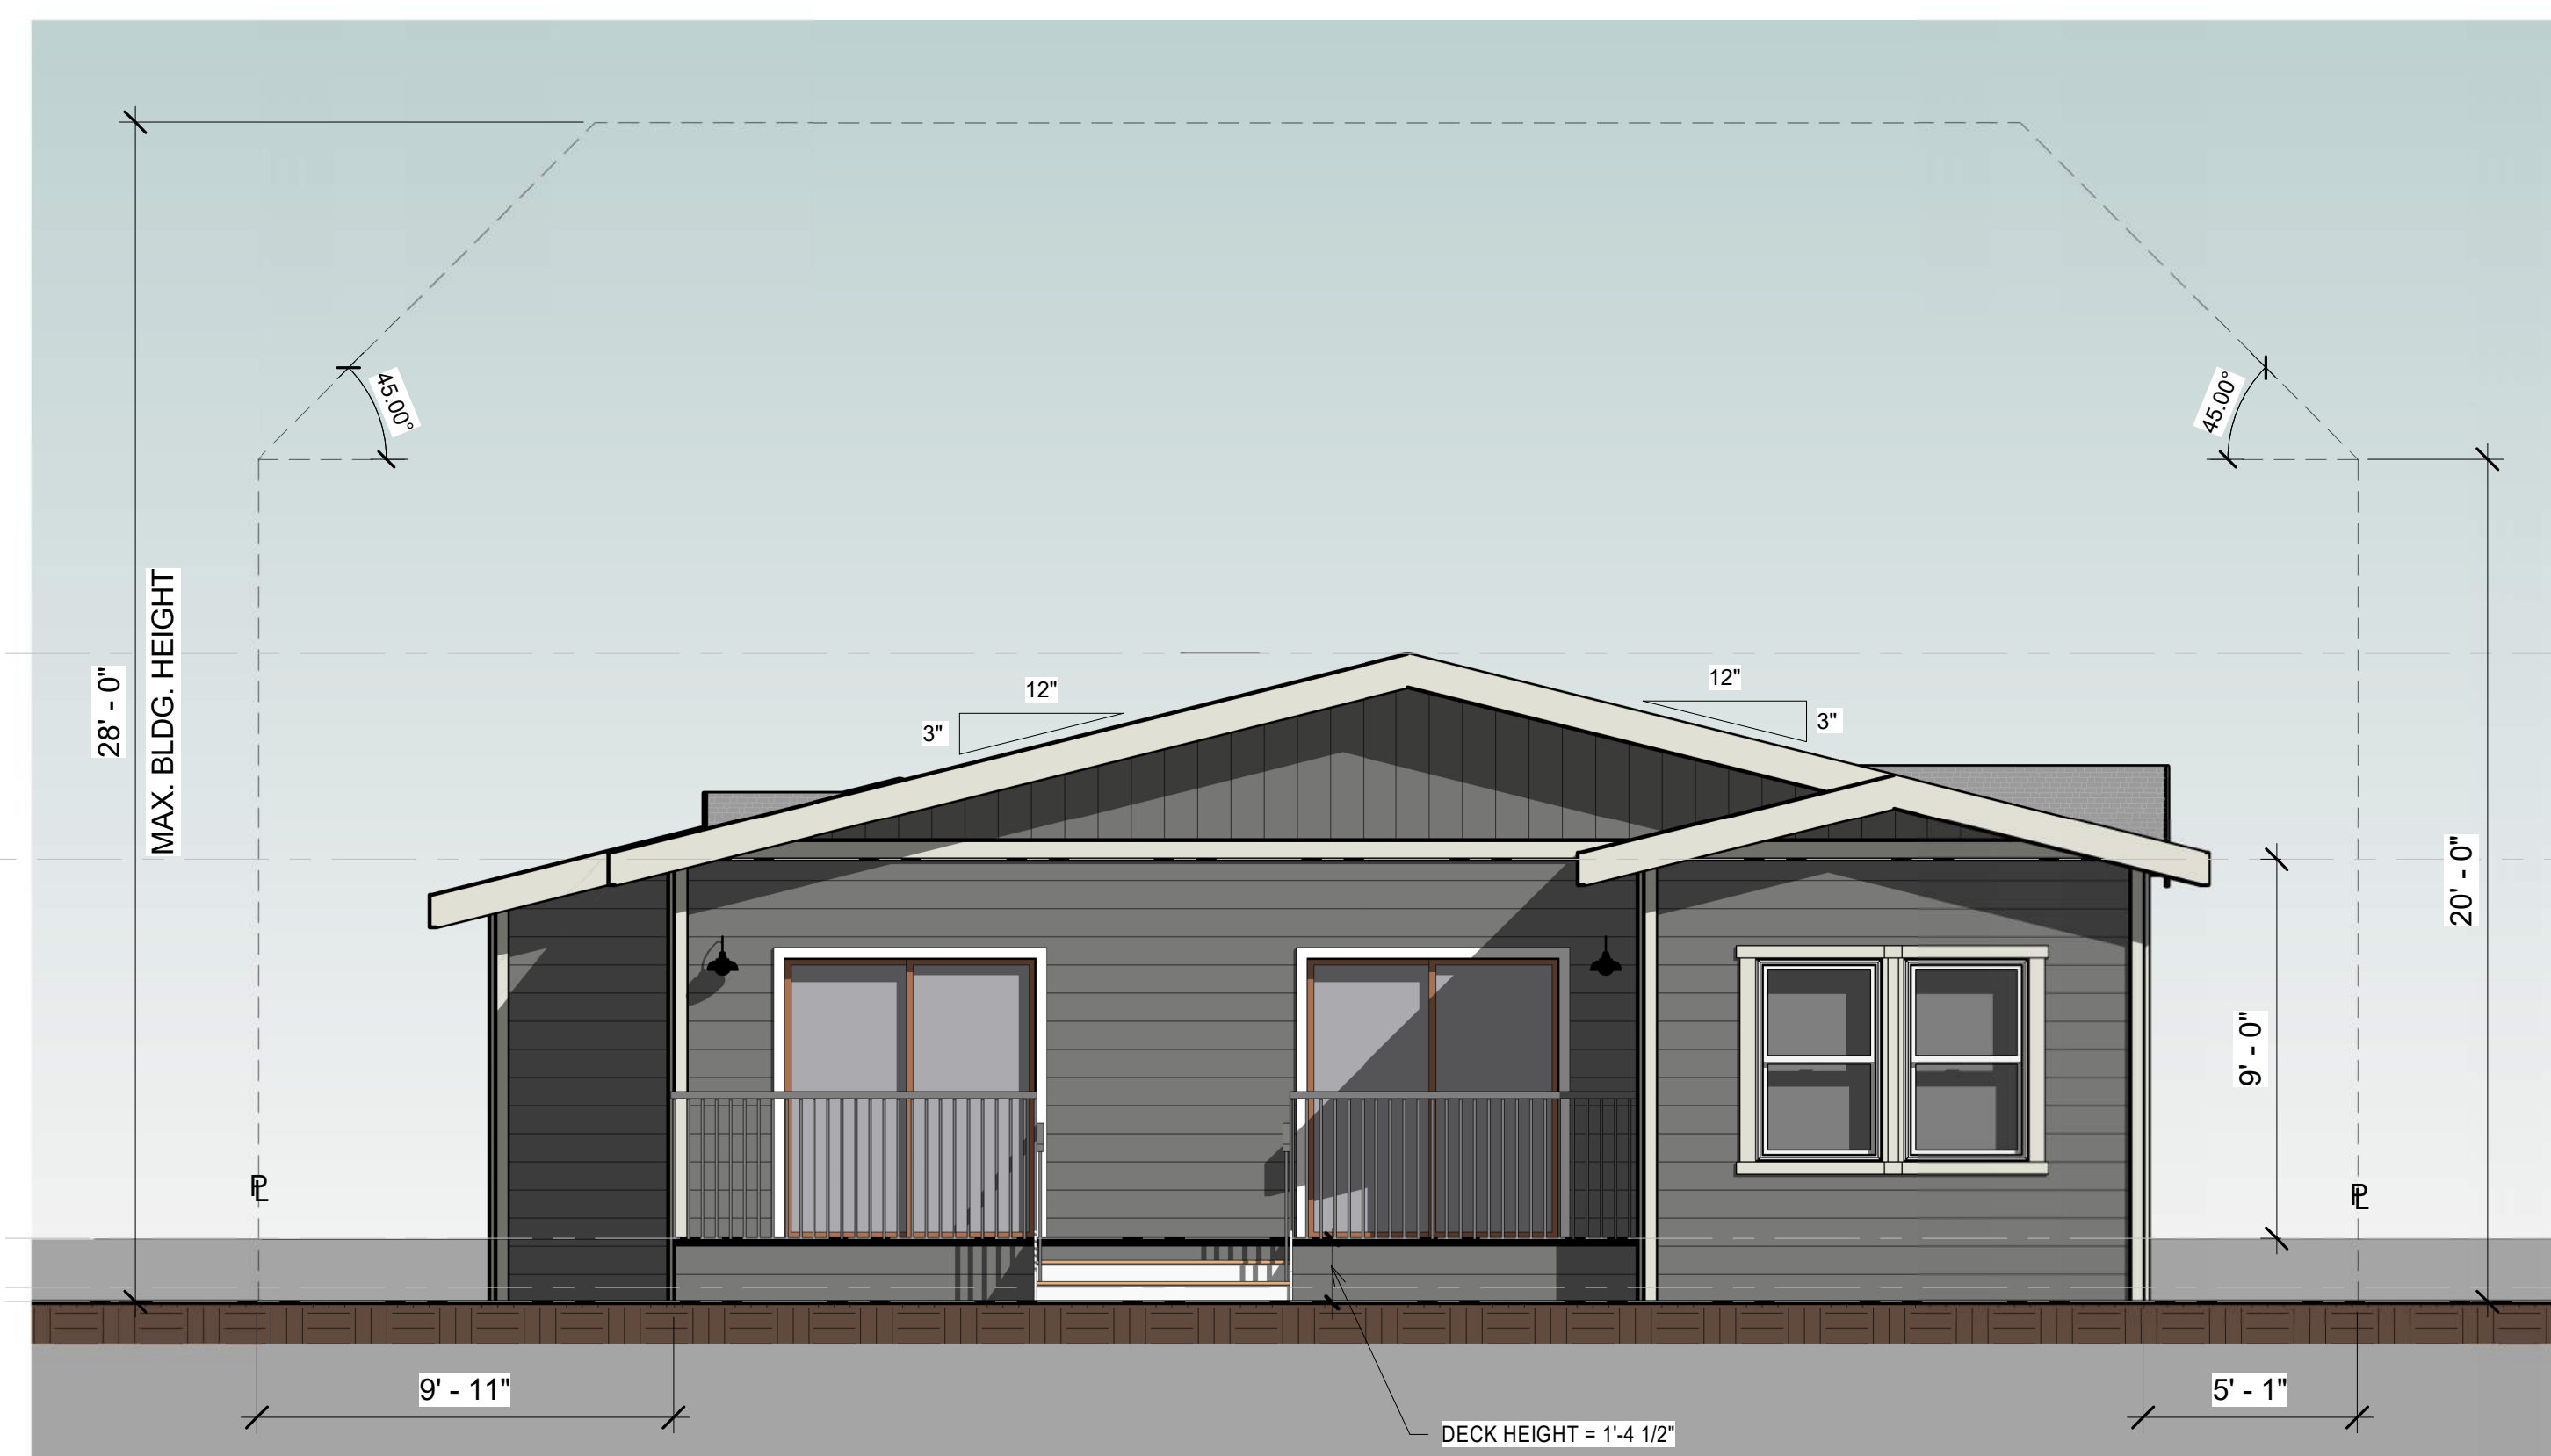
DEWETT RESIDENCE
MOSS BEACH, CA 94038
037-118-100

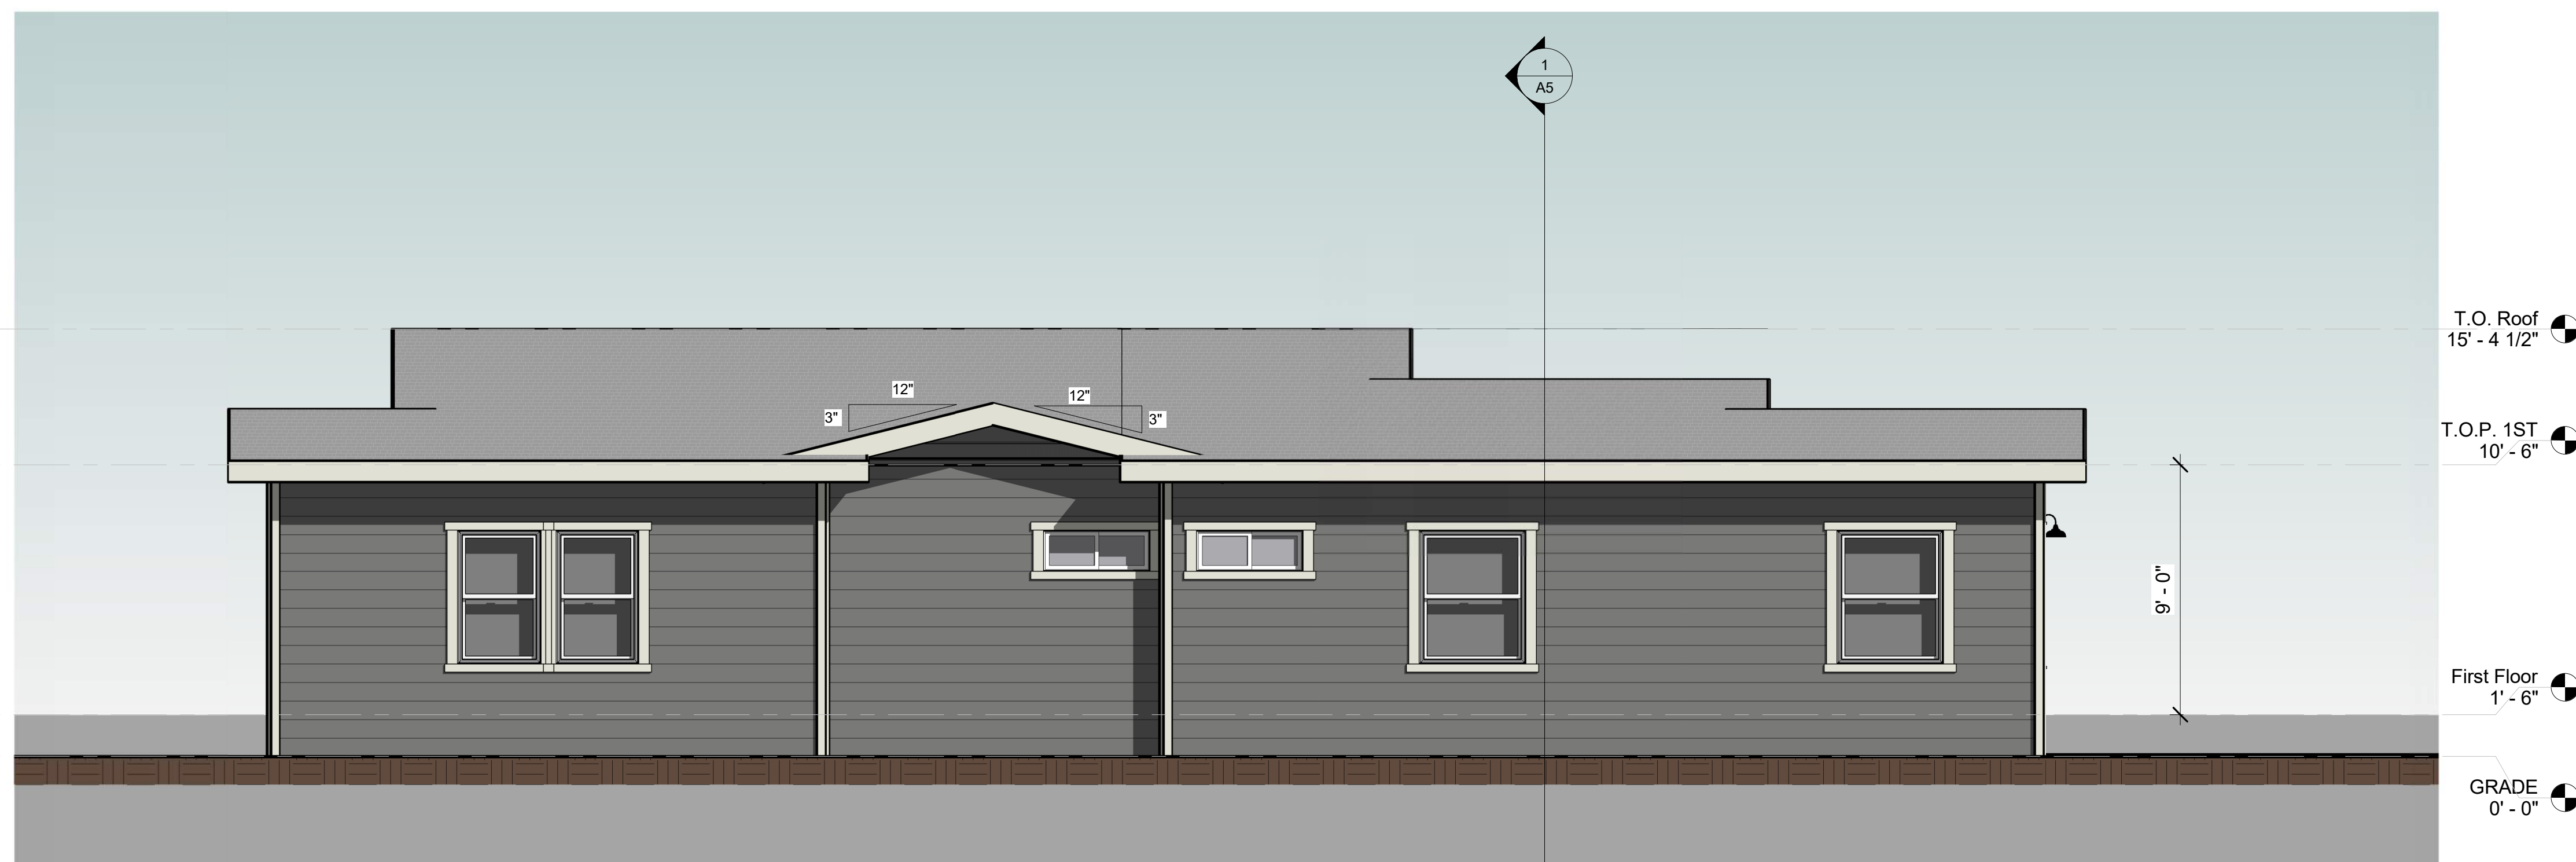

② Left Side Elevation
1/4" = 1'-0"




NOTE:
AS PER CODE, 18" CRAWL SPACE IS REQUIRED. FOUNDATION AND DRAINAGE BY OTHERS.

PLANNING REQUIREMENTS:
MAX. HEIGHT: 28'-0"
MAX PARCEL COVERAGE: <16'-0" = 50%



① Rear Elevation
1/4" = 1'-0"

Materials Legend

-  Roofing: Owens Corning Supreme Shingle
25-Year Class 'A'
Color: Onyx Black
-  Exterior Siding: James Hardie CemPlank
Fiber Cement Siding - Painted Sherwin
Williams Exterior Paint.
Color "Westchester Gray" SW2849
-  Window Trim and Fascia: Painted Sherwin
Williams Exterior Paint.
Color "Nuance" SW 7049

• **18" SIDEWALL EAVES SHIPPED LOOSE AND INSTALLED ON-SITE (BY OTHERS)**

• **18" ENDWALL EAVES FACTORY INSTALLED**


No.	Description	Date
A	PRELIMINARY DESIGN	2017.04.12
B	REVISED PLAN	

DEWETT RESIDENCE
1 STORY HOME
Rear & Left Side Elevations

Project number	
Date	2017.04.12
Drawn by	ECS
Checked by	CFW

A4.1

Scale 1/4" = 1'-0"

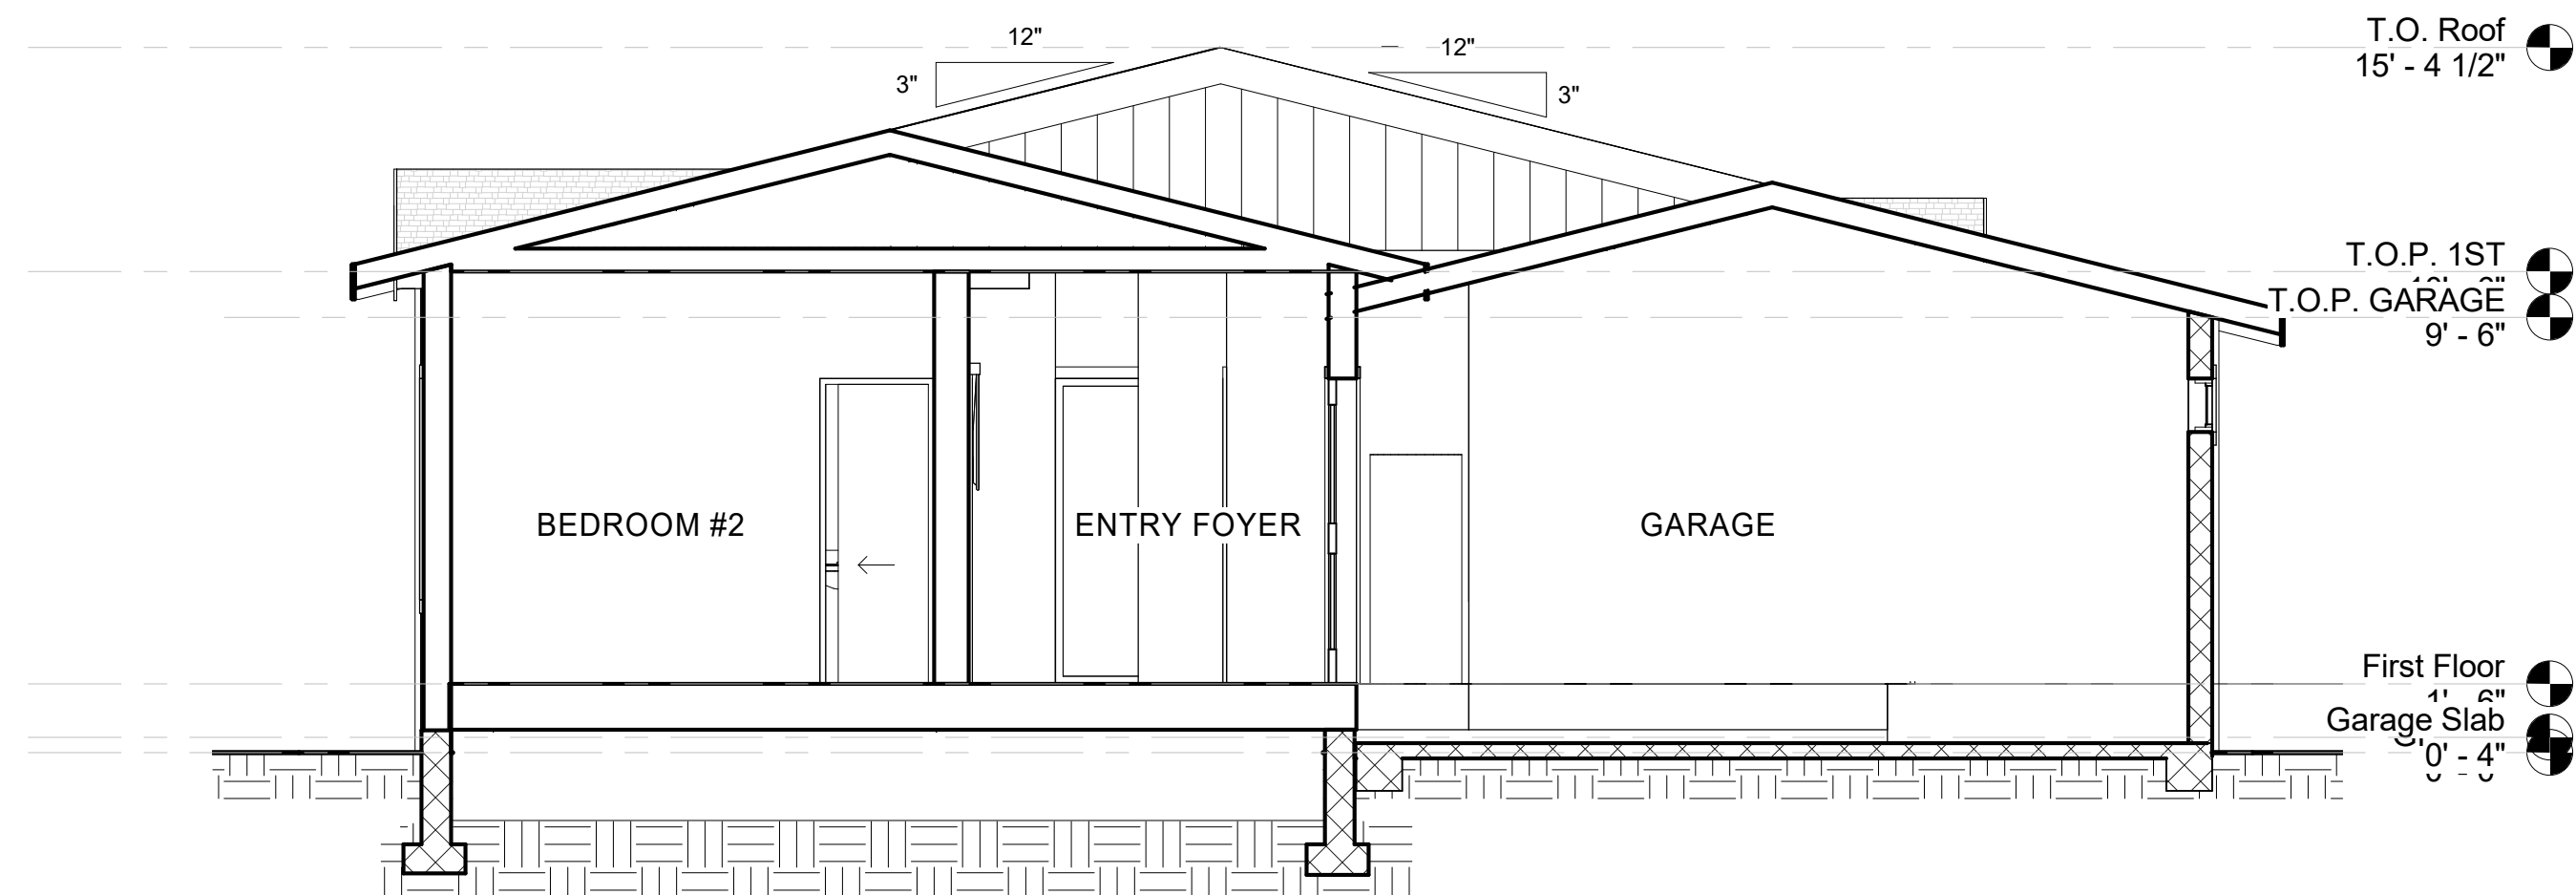

① Section 1
1/4" = 1'-0"



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DEWETT RESIDENCE
MOSS BEACH, CA 94038
037-118-100

No.	Description	Date
A	PRELIMINARY DESIGN	2017.04.12
B	REVISED PLAN	

DEWETT RESIDENCE
1 STORY HOME
Building Section

Project number	
Date	2017.04.12
Drawn by	ECS
Checked by	Checker

A5

Scale 1/4" = 1'-0"



④ 3D View 18_1
12" = 1'-0"



③ 3D View 17_1
12" = 1'-0"



② 3D View 16_1
12" = 1'-0"



① 3D View 15_1
12" = 1'-0"



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DEWETT RESIDENCE
MOSS BEACH, CA 94038
037-118-100

No.	Description	Date
A	PRELIMINARY DESIGN	2017.04.12
B	REVISED PLAN	

DEWETT RESIDENCE
1 STORY HOME
Renderings

Project number	
Date	2017.04.12
Drawn by	ECS
Checked by	CFW

A6

Scale 12" = 1'-0"

Cutting Edge Homes Window Schedule
Gold & Sterling Series
Vinyl Windows - Dual Paned - Low-E

STANDARD OPENING WINDOWS					7/12/2015					
Revised:	WINDOW NUMBER	CALL OUT	EGRESS	ROUGH OPENING	DESCRIPTION	SQ. FT. LIGHT	SQ. FT. VENT	SQ. FT. R.O.	SQ. FT. LT. AREA 8%	SQ. FT. VT. AREA 4%
W- 2				46 1/2 x 84	PARTIAL FIXED 1/4 VENT	21.30	3.70	27.13	266.25	92.50
W- 4				24 1/2 x 38 1/2	V.S.	4.48	2.14	6.55	56.00	53.50
W- 5		40 x 38 H		40 1/2 x 38 1/2	H.S.	8.01	4.33	10.83	100.13	108.25
W- 6		56 x 38 H		56 1/2 x 38 1/2	H.S.	11.81	6.30	15.11	147.63	157.50
W- 7				24 1/2 x 46 1/2	H.S.	5.58	2.58	7.91	69.75	64.50
W- 8		96 x 39 H	Yes	96 1/2 x 40	H.S. XOX	21.26	11.19	26.81	265.75	279.75
W- 9E		96 x 58 H	Yes	96 1/2 x 59	H.S. XOX	31.85	16.18	39.54	398.13	404.50
W-10E		78 x 58 H	Yes	78 1/2 x 59	H.S. XOX	26.01	15.37	32.16	325.13	384.25
W-12		46 x 10 H		46 1/2 x 10 1/4	H.S.	1.57	1.25	3.23	19.63	31.25
W-16		24 x 27 H		24 1/2 x 27 1/4	H.S. OBS	2.83	1.61	4.63	35.38	40.25
W-17		46 x 48 H OBS	Yes	46 1/2 x 48 1/4	H.S. (SAFETY) OBS	12.12	6.46	15.54	151.50	161.50
W-20		24 x 80 V		24 1/2 x 80 1/2	PARTIAL FIXED 1/4 VENT	10.17	3.98	13.70	127.13	99.50
W-21E		36 x 80 V	(mulled)	36 1/2 x 80 1/2	PARTIAL FIXED 1/4 VENT	16.10	6.19	20.40	201.25	154.75
W-22E		46 x 80 V	(mulled)	46 1/2 x 80 1/2	PARTIAL FIXED 1/4 VENT	21.04	8.04	25.99	263.00	201.00
W-24		46 x 52 VS		46 1/2 x 52 1/2	PARTL FIXED 1/4 VENT(SAFETY)	12.91	3.42	16.95	161.38	85.50
W-25		36 x 52 V		36 1/2 x 52 1/2	PARTIAL FIXED 1/4 VENT	9.90	2.63	13.31	123.75	65.75
W-28E		30 x 80 V	(mulled)	30 1/2 x 80 1/2	V.S. 1/2 VENT	13.14	5.11	17.05	164.25	127.75
W-33		46 x 39 H OBS		46 1/2 x 40	H.S. (SAFETY) OBS	9.82	5.27	12.92	122.75	131.75
W-35E		30 x 58 V		30 1/2 x 59	V.S. 1/2 VENT	9.48	5.08	12.50	118.50	127.00
W-37		24 1/2 x 58 7/8			V.S.	7.31	3.98	10.01	91.38	99.50
W-38		14 1/2 x 58 7/8			V.S.	3.70	2.13	5.93	46.25	53.25
W-45		24 x 39 V		24 1/2 x 40	V.S.	4.65	2.41	6.80	58.13	60.25
W-46		30x12 P		30 1/2 x 12 1/2	FIXED	1.89	0.00	2.65	23.63	0.00
W-47				21 1/2 x 59	V.S.	6.23	3.42	8.81	77.88	85.50
W-48		36 x 25 P		36 1/2 x 25	FIXED	5.17	0.00	6.33	64.63	0.00
W-49		30 x 25 P		30 1/2 x 25	FIXED	4.24	0.00	5.30	53.00	0.00
W-50		46 x 25 P		46 1/2 x 25	FIXED	6.70	0.00	8.07	83.75	0.00
W-63E		36 x 58 V	Yes	36 1/2 x 59	V.S. 1/2 VENT	11.65	6.19	14.95	145.63	154.75
W-64E		46 x 58 V	Yes	46 1/2 x 59	V.S. 1/2 VENT	15.27	8.04	19.05	190.88	201.00
W-65E		62 x 52 H	Yes	62 1/2 x 52 1/2	H.S.	18.65	9.82	22.79	233.13	245.50
W-71				40 1/2 x 36 1/4	V.S. 1/2 VENT	7.49	2.56	10.20	93.63	64.00
W-72		30 x 39 V		30 1/2 x 40	V.S. 1/2 VENT	6.03	3.08	8.47	75.38	77.00
W-73		30 x 36 V		30 1/2 x 36 1/4	V.S. 1/2 VENT	5.37	2.73	7.60	67.13	68.25
W-74E				30 1/2 x 54 1/2	V.S. 1/2 VENT	8.65	4.25	11.54	108.13	106.25
W-75		24 x 54 VS		24 1/2 x 54 1/2	V.S. VENT (SAFETY)	6.60	3.32	9.27	82.50	83.00
W-76		14 x 39 VO		14 1/2 x 40	V.S. VENT OBS	2.35	1.29	4.02	29.38	32.25
W-77E				36 1/2 x 54 1/2	V.S. 1/2 VENT	10.63	5.18	13.81	132.88	129.50
W-79		24 x 54 V		24 1/2 x 54 1/2	V.S. VENT OBS (SAFETY)	6.60	3.32	9.27	82.50	83.00
W-80				24 1/2 x 84 1/2	PARTL FIXED 1/4 VENT	10.77	3.98	14.09	134.63	99.50
W-81E				36 1/2 x 84 1/2	PARTL FIXED 1/4 VENT	17.03	6.19	21.10	212.88	154.75
W-82E				46 1/2 x 84 1/2	PARTL FIXED 1/4 VENT	22.25	8.04	25.95	278.13	201.00
W-84				46 1/2 x 60 1/2	PARTL FIXED 1/4 VENT(SAFETY)	15.26	3.42	19.26	190.75	85.50
W-85				36 1/2 x 60 1/2	PARTL FIXED 1/4 VENT	11.71	2.63	15.08	146.38	65.75
W-88				36 1/2 x 65 1/4	V.S. (SAFETY)	13.08	6.94	16.54	163.50	173.50
W-91		30 x 27 V		30 1/2 x 27 1/4	V.S. 1/2 VENT	3.73	2.06	5.77	46.63	51.50
W-93E		73 x 59 V DBL		73 1/4 x 59	V.S. 1/2 VENT, MULLED	23.30	12.38	30.01	291.25	309.50
W-98				36 1/2 x 42 1/4	V.S.	7.94	4.03	10.71	99.25	100.75
XXX		46 x 18		46 x 18	ABOVE SHOWERS/COMBOS HS					
STANDARD FIXED WINDOWS					7/12/2015					
Revised:	WINDOW NUMBER	CALL OUT	EGRESS	ROUGH OPENING	DESCRIPTION	SQ. FT. LIGHT	SQ. FT. VENT	SQ. FT. R.O.	SQ. FT. LT. AREA	SQ. FT. VT. AREA
W- 1				46 1/2 x 16 7/8 x 25 3/4	FIXED PENTAGON	4.83	0.00	6.88	60.38	0.00
W- 3				24 1/2 x 30 1/2	FIXED	4.24	N/A	5.19	53.00	0.00
W-13		46 x 10 P		46 1/2 x 10 1/4	FIXED	2.23	0.00	3.23	27.88	0.00
W-14*		18 x 18 BLOCK		17 5/8 x 17 5/8	18" SQUARE ACRYLIC BLOCK	1.77	0.00	2.16	22.13	0.00
W-15*		48 x 48 BLOCK		48 1/4 x 48 1/4	48" SQUARE ACRYLIC BLOCK	14.69	0.00	16.17	183.63	0.00
W-23		36 x 10 P		36 1/2 x 10 1/4	FIXED	1.72	0.00	2.53	21.50	0.00
W-26		12 x 72 P		12 1/2 x 72 1/4	FIXED (SAFETY)	4.64	0.00	6.00	58.00	0.00
W-29		72 x 12 P		72 x 12 1/4	FIXED	4.50	0.00	6.13	56.25	0.00
W-30		75 x 12 P		75 x 12 1/4	FIXED	4.71	0.00	6.38	58.88	0.00
W-31		PRISM		62 1/2 x 15 x 26 1/2 x 15	FIXED PENTAGON	4.70	0.00	4.76	58.75	0.00
W-39				31 x 15 1/2	1/2 ROUND FIXED	1.80	0.00	2.62	22.50	0.00
W-40				47 x 23 1/2	1/2 ROUND FIXED	4.70	0.00	6.02	58.75	0.00
W-83				36 1/2 x 16	FIXED	3.06	0.00	4.15	38.25	0.00
W-89		24 x 14 P		24 1/2 x 14 1/4	FIXED	1.71	0.00	2.42	21.38	0.00
W-90		36 x 14 P		36 1/2 x 14 1/4	FIXED	2.66	0.00	3.61	33.25	0.00
W-92		73 x 14 P		73 1/4 x 14 1/4	FIXED	5.56	0.00	7.25	69.50	0.00
W-94				23 x 23	FIXED - OCTAGON	2.18	0.00	2.37	27.25	0.00
W-97				49 x 49	PW	14.77	0.00	17.01	184.63	0.00

2016



THESE CONSTRUCTION DOCUMENTS CREATED BY CUTTING EDGE HOMES ARE AN INSTRUMENT OF SERVICE PROVIDED TO THE OWNER BY THE DESIGNER. THESE DOCUMENTS ARE OWNED BY THE DESIGNER AND COPIES FOR APPROPRIATE PERMITS AND CONSTRUCTION SHALL BE PROVIDED TO THE OWNER. THESE DOCUMENTS SHALL NOT BE USED FOR ANY PROJECT OTHER THAN THE SPECIFIC PROJECT CONTRACT FOR. NO EXCEPTIONS.

DEWETT RESIDENCE
MOSS BEACH, CA 94038
037-118-100

WINDOW SCHEDULE 1

Door Schedule (EXTERIOR)						
Mark	Type	Width	Height	Function	Level	Style
59	16'-0" x 8'-0"	16' - 0"	8' - 0"	Exterior	Garage Slab	
65	36" x 80"	3' - 0"	6' - 8"	Exterior	First Floor	

Door Schedule (INTERIOR)				
Mark	Width	Height	Function	Comments
51	2' - 6"	7' - 0"	Interior	
63	2' - 6"	7' - 0"	Interior	
83	6' - 0"	6' - 8"	Interior	
84	6' - 0"	6' - 8"	Interior	
85	2' - 6"	6' - 8"	Interior	
87	3' - 0"	6' - 8"	Interior	
99	4' - 0"	6' - 8"	Interior	
100	4' - 0"	6' - 8"	Interior	
101	2' - 6"	6' - 8"	Interior	
103	2' - 6"	6' - 8"	Interior	

Door Schedule (INTERIOR)				
Mark	Width	Height	Function	Comments
105	2' - 6"	6' - 8"	Interior	
106	2' - 0"	6' - 8"	Interior	
107	2' - 6"	6' - 8"	Interior	
109	6' - 0"	6' - 8"	Interior	
110	6' - 0"	6' - 8"	Interior	
111	2' - 6"	6' - 8"	Interior	
112	2' - 6"	6' - 8"	Interior	
113	2' - 6"	6' - 8"	Interior	

No.	Description	Date
A	PRELIMINARY DESIGN	2017.04.12
B	REVISED PLAN	

DEWETT RESIDENCE
1 STORY HOME
Schedules

Project number	
Date	2017.04.12
Drawn by	ECS
Checked by	CFW

A7

Scale

DEWETT RESIDENCE

VIRGINIA AVENUE MOSS BEACH, CALIFORNIA




CIVIL ENGINEERING
&
LAND PLANNING


YANG CONSULTING GROUP
490 Post Street, Suite 406
San Francisco, CA, 94102
Ph. 510.730.2080
andrew@ycg-inc.com
Andrew Yang, PE QSD
PRINCIPAL CIVIL ENGINEER



11/29/2018

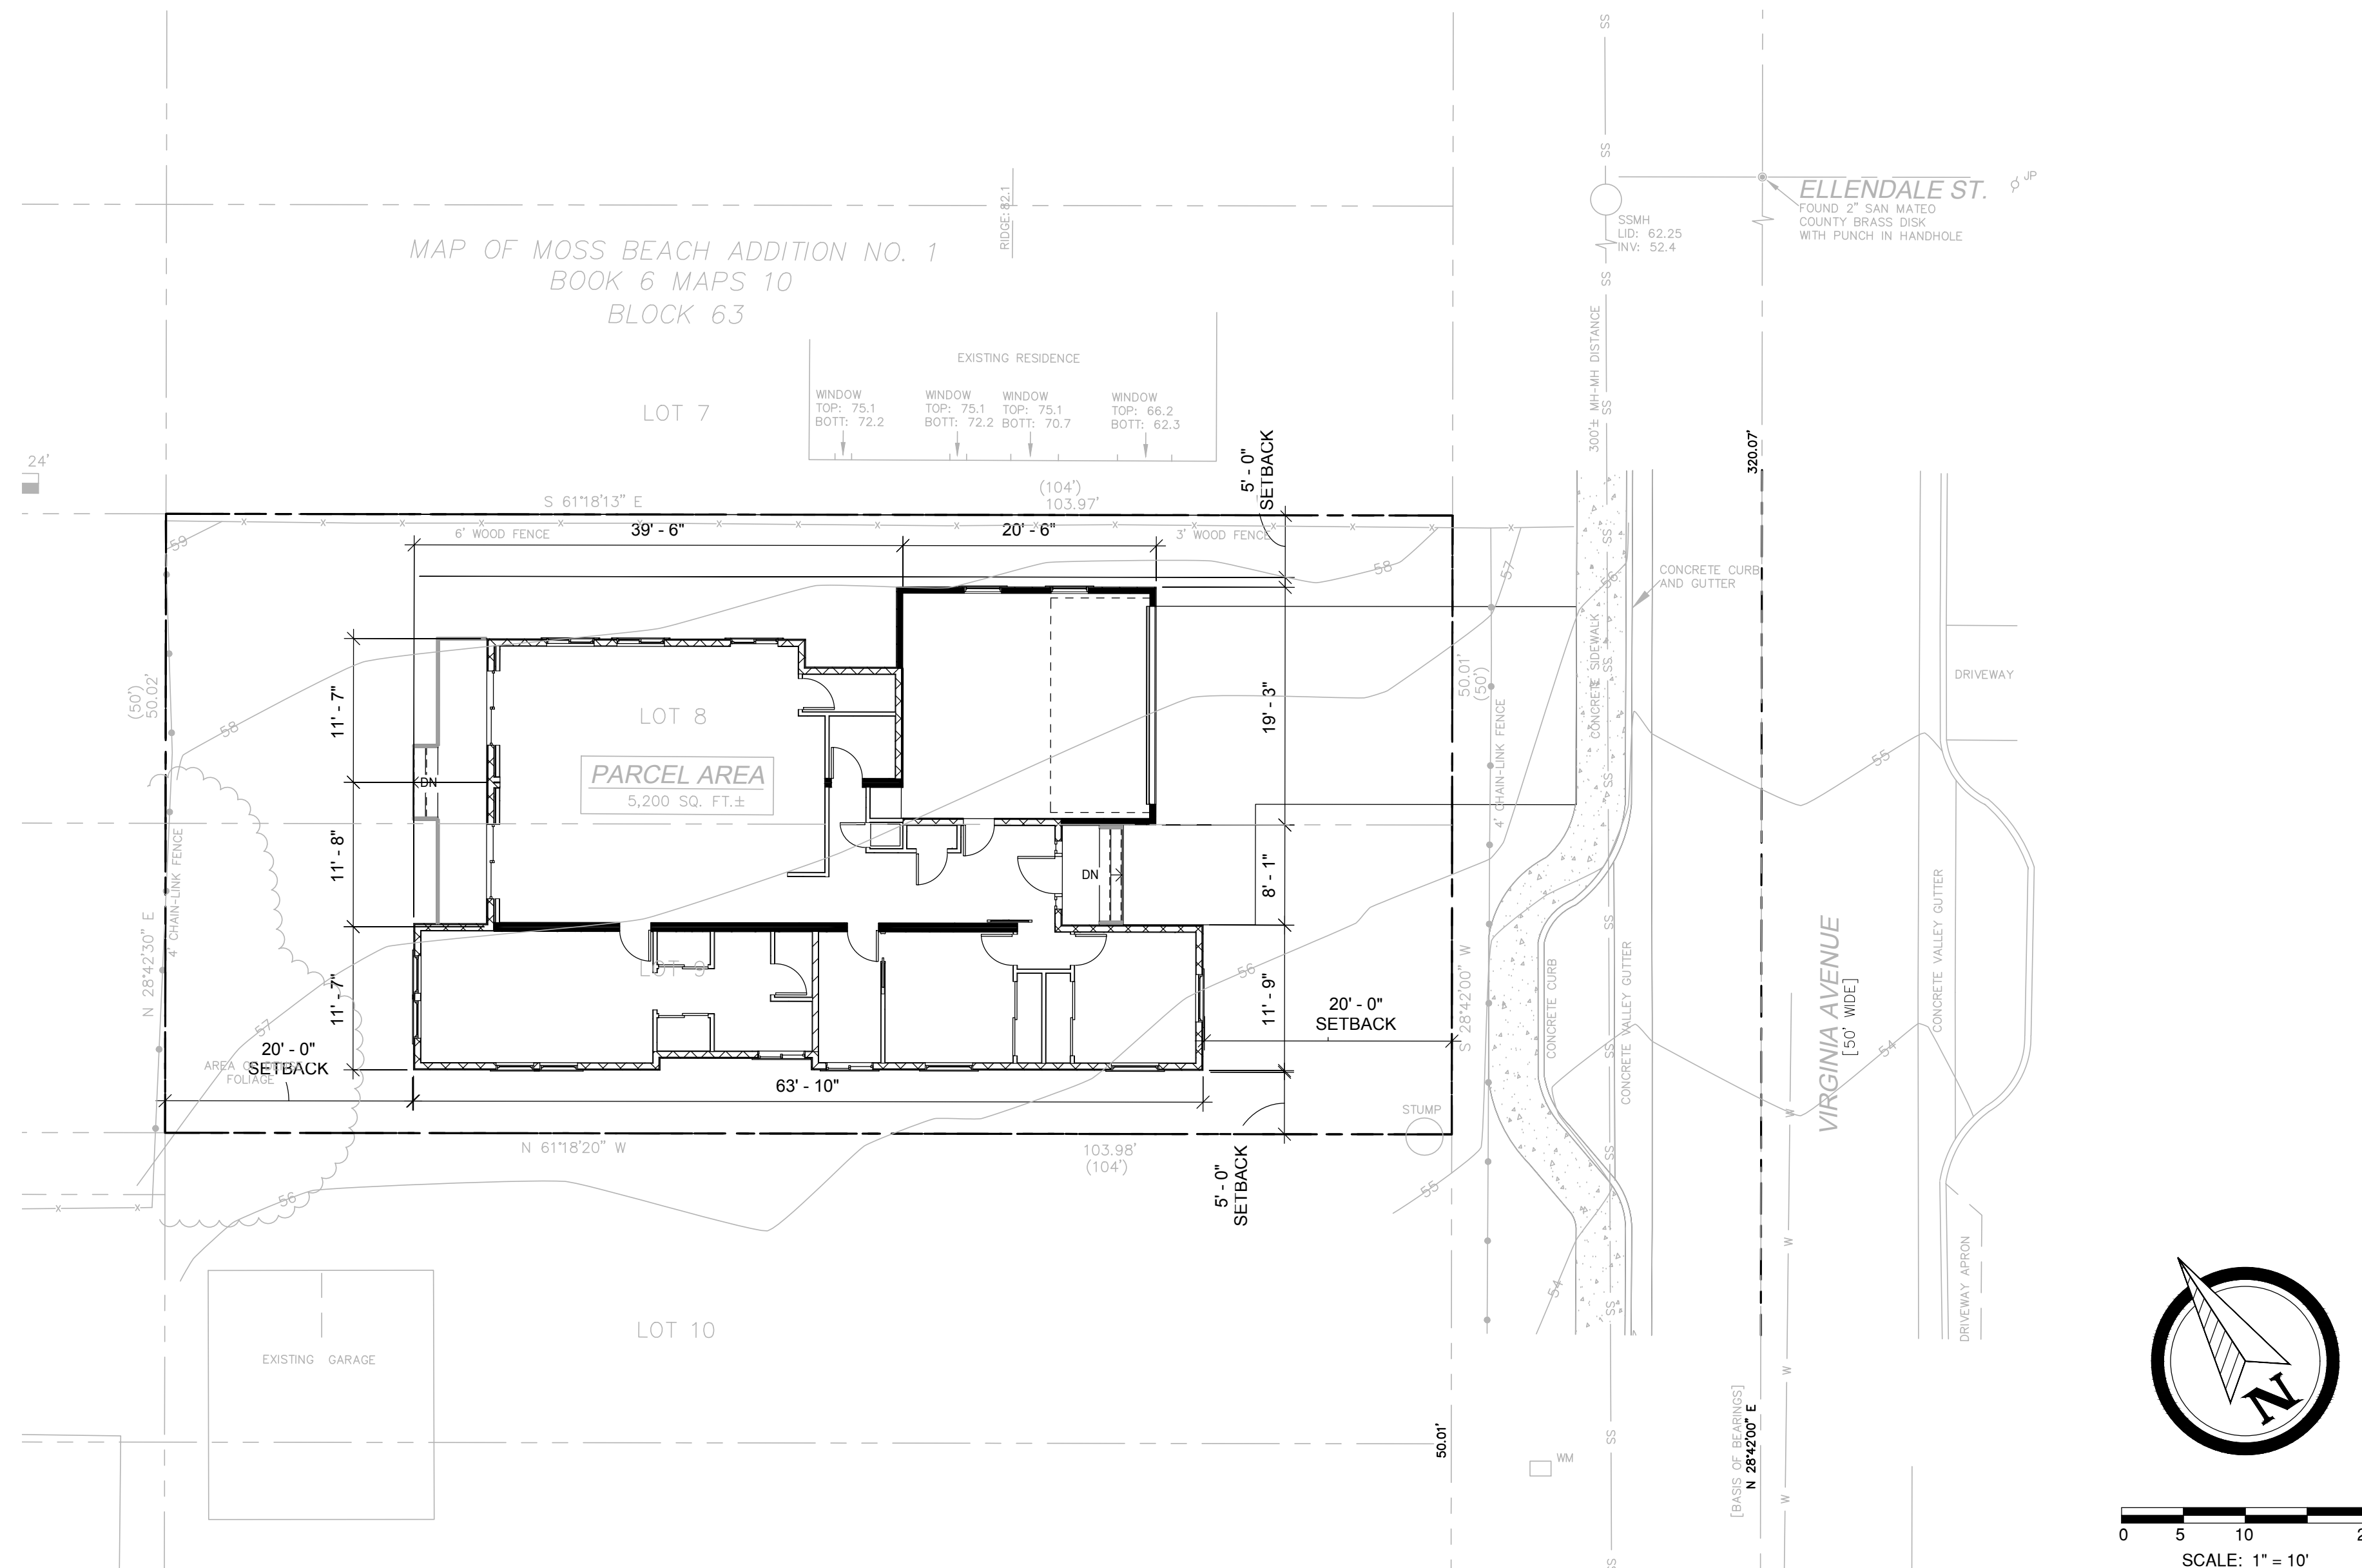

VICINITY MAP

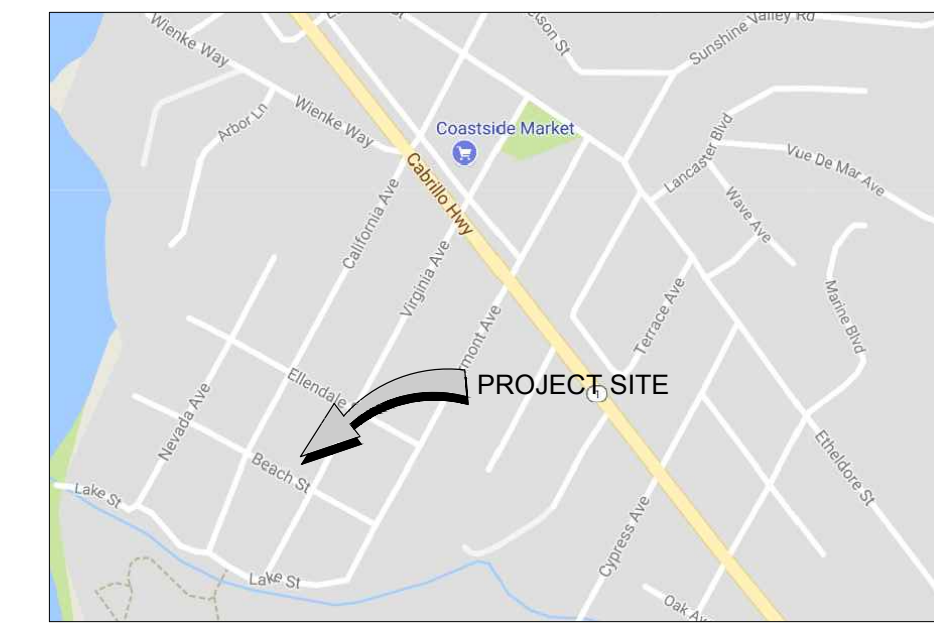

N.T.S

LOT AREA:
5,200 SQUARE FEET
APN: 037-118-100


LEGEND:

- 0.00 (E) OR 0.00 (E) EXISTING SPOT ELEVATION
- DIRECTION OF DRAINAGE FLOW
- CEDAR FENCE LINE
- PROPERTY LINE
- BIO RETENTION
- CONCRETE
- DRIVEWAY

FLOOD ZONE NOTE

THIS PROJECT IS IN FLOOD ZONE X - AREA WHERE THERE ARE MINIMAL FLOOD HAZARDS, FEDERAL EMERGENCY MANAGEMENT AGENCY (F.E.M.A.) FLOOD INSURANCE RATE MAP (F.I.R.M.) ON IN COMMUNITY

PANEL NO: 06081C0119F
DATED: AUGUST 2, 2017

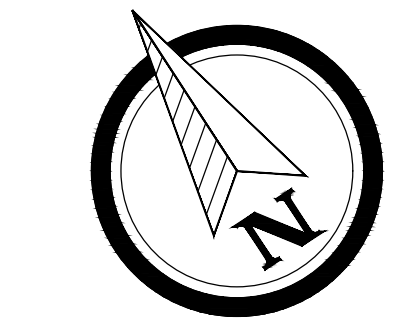

SCALE: 1" = 10'

BASIS OF BEARINGS

THE BEARING, NORTH 28°42'00" EAST, OF THE MONUMENTED CENTERLINE OF VIRGINIA AVENUE, AS SHOWN ON THAT CERTAIN RECORD OF SURVEY BY THE COUNTY OF SAN MATEO WHICH WAS FILED FOR RECORD IN VOLUME 14 OF LLS MAPS AT PAGE 18 ON APRIL 23, 1992, SAN MATEO COUNTY RECORDS, WAS USED AS THE BASIS OF BEARINGS FOR THIS SURVEY.

PROJECT BENCHMARK

ELEVATIONS SHOWN HEREON ARE BASED UPON NAVD 88 DATUM. BENCHMARK USED WAS THE NGS DISK "S 1240" (PID HT1812), A BRONZE DISK IN THE TOP AND 1.2 FEET NORTHWEST OF THE SOUTHEAST END OF THE NORTHEAST CONCRETE HEADWALL AT THE NORTHEASTERLY JUNCTION OF STATE HIGHWAY 1 AND ETHELDORE STREET. ELEVATION: 60.91 FEET. LOCAL BENCHMARK IS THE SAN MATEO COUNTY BRASS DISK IN HANDHOLE AT THE INTERSECTION OF VIRGINIA AVENUE AND BEACH STREET WITH AN ELEVATION OF 50.75 FEET.

ENCROACHMENT PERMIT

AN ENCROACHMENT PERMIT FOR THE DRIVEWAY APPROACH AND SANITARY SEWER CONNECTIONS NEEDS TO BE ISSUED PRIOR TO BUILDING PERMIT ISSUANCE.

GENERAL NOTES

- CONTRACTOR SHALL VERIFY THE LOCATION OF ALL UTILITIES PRIOR TO CONSTRUCTION.
- 1' CONTOUR INTERVAL.

SHEET INDEX:

- C1 SITE PLAN
- C2 GRADING AND DRAINAGE PLAN
- C3 UTILITY PLAN
- C4 EROSION CONTROL PLAN

NEW S.F.R. CONSTRUCTION FOR
DEWETT RESIDENCE
VIRGINIA AVENUE
MOSS BEACH, CA 94038

Project Number
CTE17006

Sheet Name

SITE PLAN

Sheet Number

C1



1/17/2019


REVISION	DATE	RESPONSE TO COMMENTS
1	1-29-18	RESPONSE TO COMMENTS
2	11-29-18	RESPONSE TO COMMENTS

NEW S.F.R. CONSTRUCTION FOR DEWEET RESIDENCE
VIRGINIA AVENUE
MOSS BEACH, CA 94038

Project Number
CTE17006

Sheet Name
GRADING PLAN

Sheet Number
C2

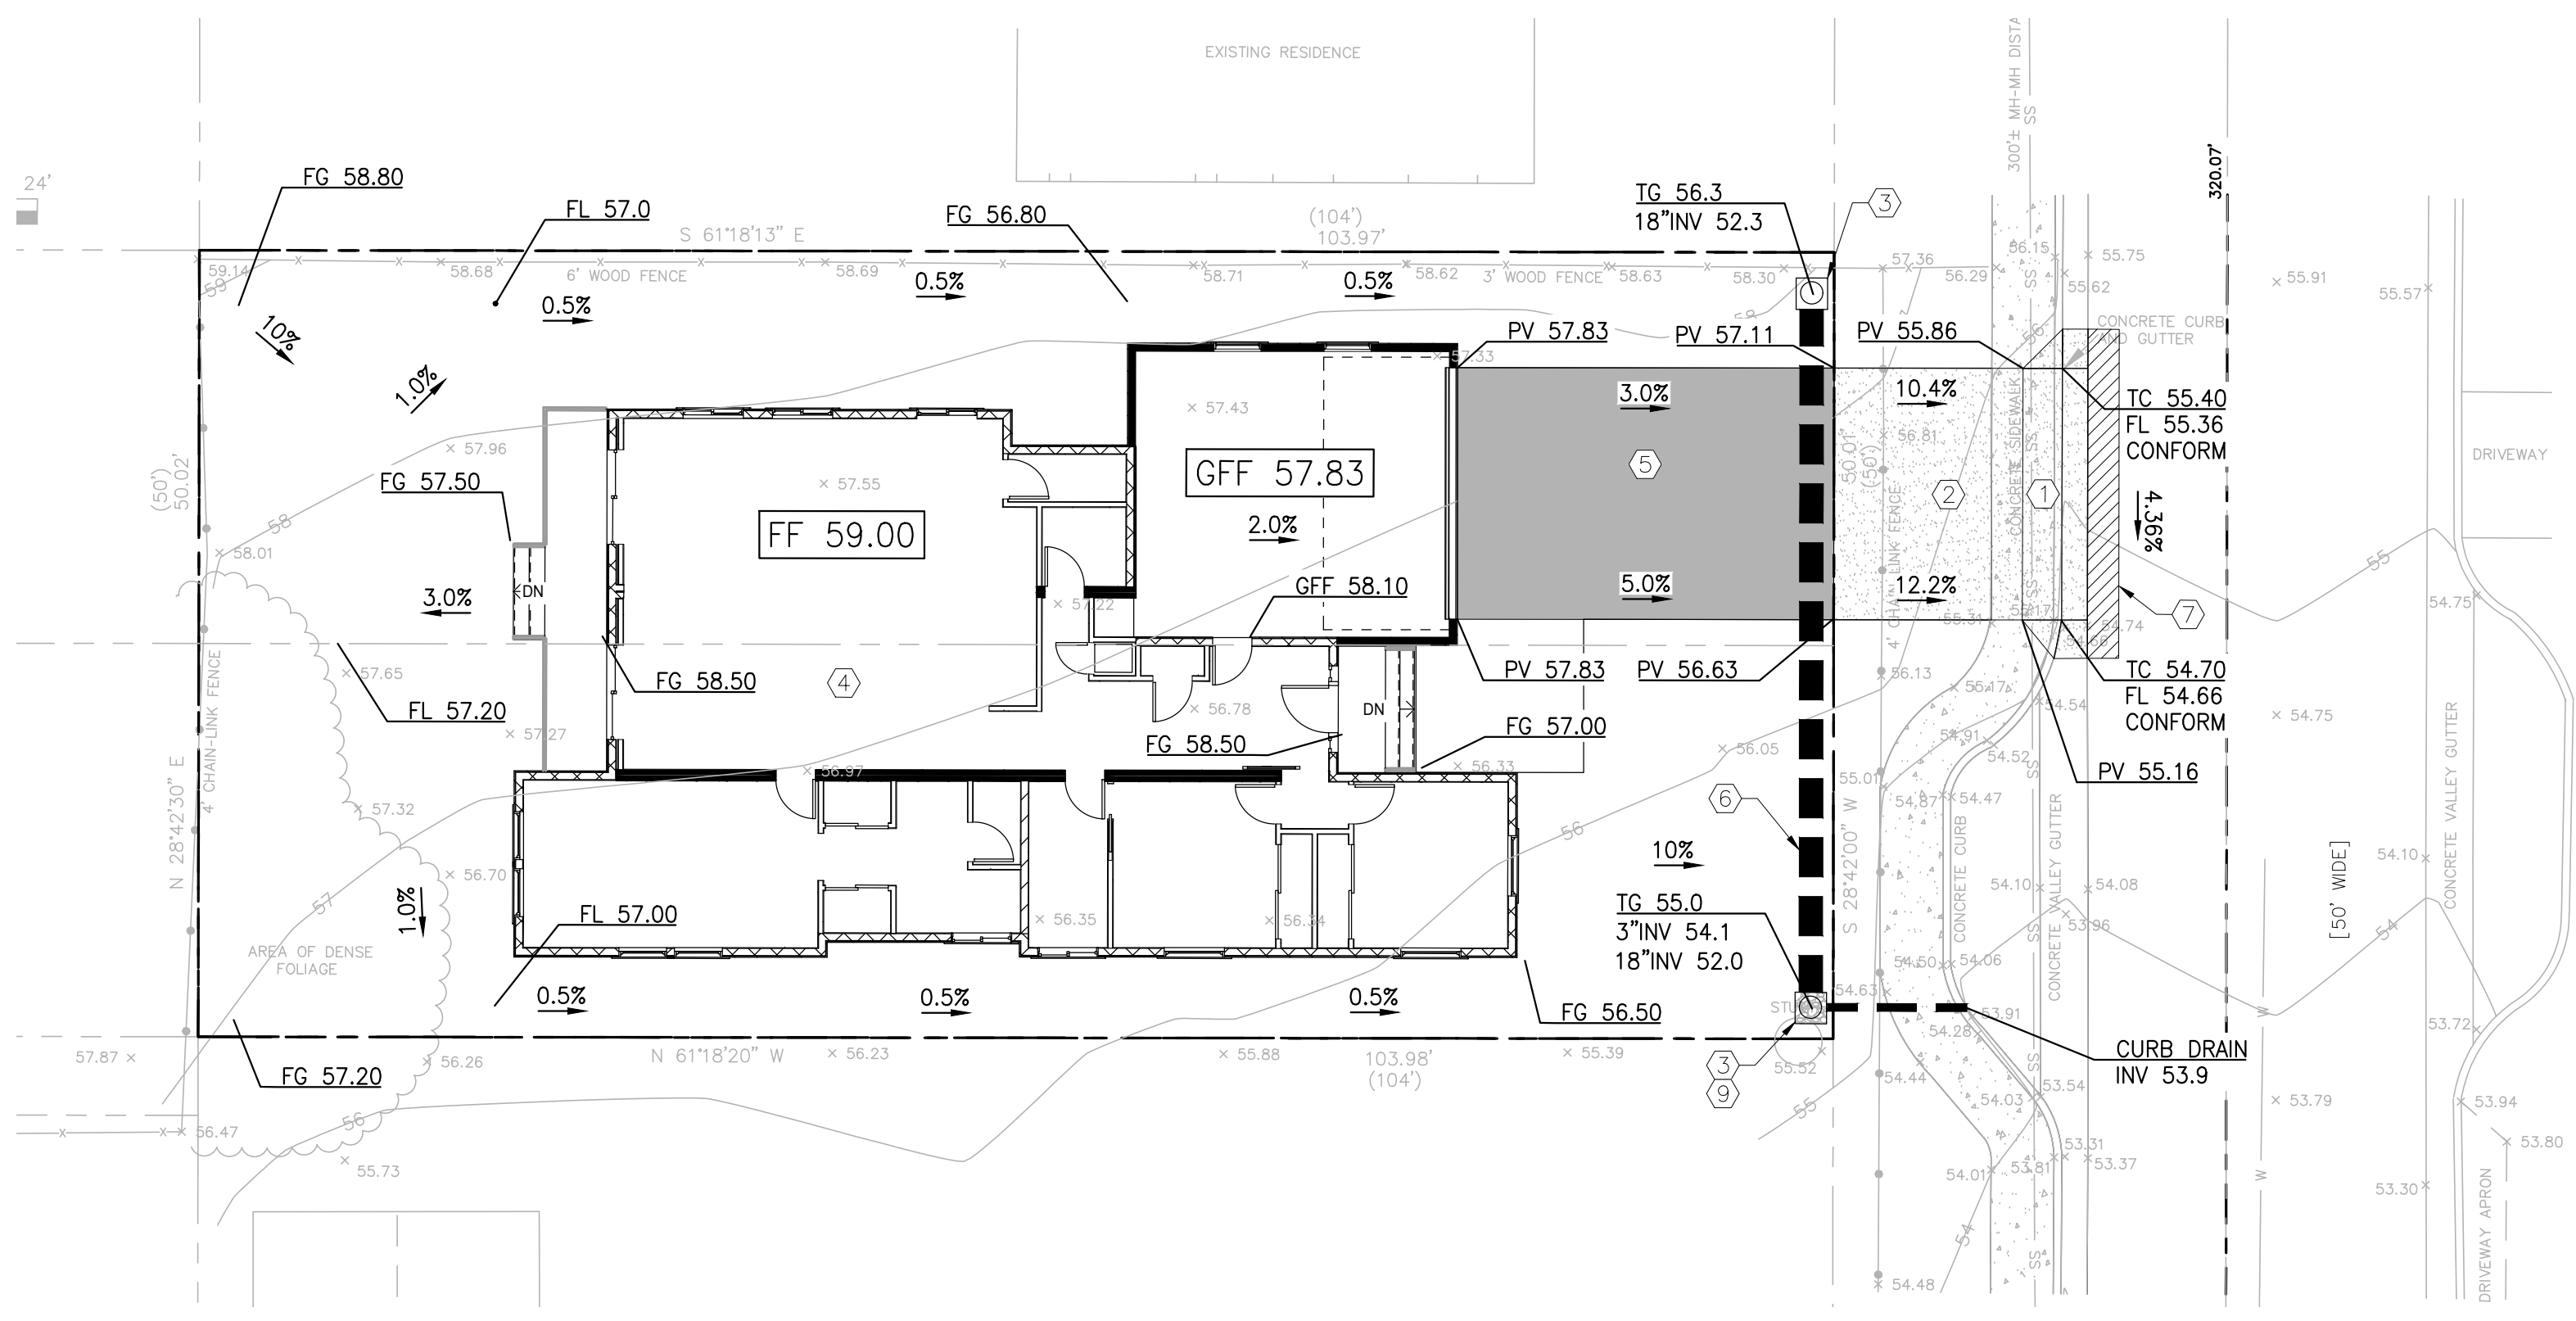

KEY NOTES:

ITEM	DESCRIPTION
1	REMOVE EXISTING SIDEWALK CURB AND GUTTER.
2	NEW RESIDENTIAL DRIVEWAY APPROACH PER COUNTY DETAIL D-1. COORDINATE ALL RIGHT OF WAY ENCROACHMENT WORK WITH COUNTY ROAD INSPECTOR AT PRE-CONSTRUCTION MEETING.
3	INSTALL NDS 18"x18" EXPANDABLE CATCH BASIN SKU#1804 OR EQUIVALENT. CONNECT DRAIN TO UNDER CURB DRAIN VIA 3" PVC PIPE.
4	BUILDING FOUNDATION, REFER TO SOIL ENGINEER'S RECOMMENDATION FOR PAD PREPARATION AND FOUNDATION SECTIONS.
5	CONCRETE PAVING, REFER TO DETAIL 1 ON THIS SHEET FOR RECOMMENDED PAVING SECTIONS. ALSO CONSIDER SOIL REPORT PART OF THIS PLAN.
6	18" SOLID PVC PIPE AS UNDERGROUND DETENTION PIPE SYSTEM.
7	SAWCUT 2" FROM EXISTING EDGE OF PAVEMENT, GRIND AND OVERLAY AT 0.17" DEPTH.
8	INSTALL SPLASH BLOCKS AT DOWNSPOUT LOCATIONS.
9	PROVIDE 24" OF 3/4" CLASS II CRUSHED ROCK UNDER CATCH BASIN. DRILL HOLES AT BOTTOM OF THIS CATCH BASIN TO PREVENT STANDING WATER.


GRADING LEGEND:

- 0.00 (E) OR 0.00 (E) EXISTING SPOT ELEVATION
- 0.00 PROPOSED ELEVATION
- Direction of Drainage Flow
- RIDGE LINE/ GRADE BREAK
- LIMIT OF WORK
- CONCRETE PAVING
- NEW AC & AB
- GRIND & OVERLAY

PV EDGE OF PAVEMENT
 BW BACK OF WALK
 FF FINISH FLOOR
 FG FINISH GRADE
 FL FLOW LINE
 GFF GARAGE FINISH FLOOR
 GB GRADE BREAK
 LIP EDGE OF SWALE OR GUTTER
 HP HIGH POINT
 ME MATCH EXISTING
 TC TOP OF CURB
 C CONCRETE
 TS TOP OF SLAB
 TG TOP OF GRATE

EARTHWORKS:

FILL: 35 CUBIC YARDS
 CUT: 45 CUBIC YARDS
 EXPORT: 10 CUBIC YARDS

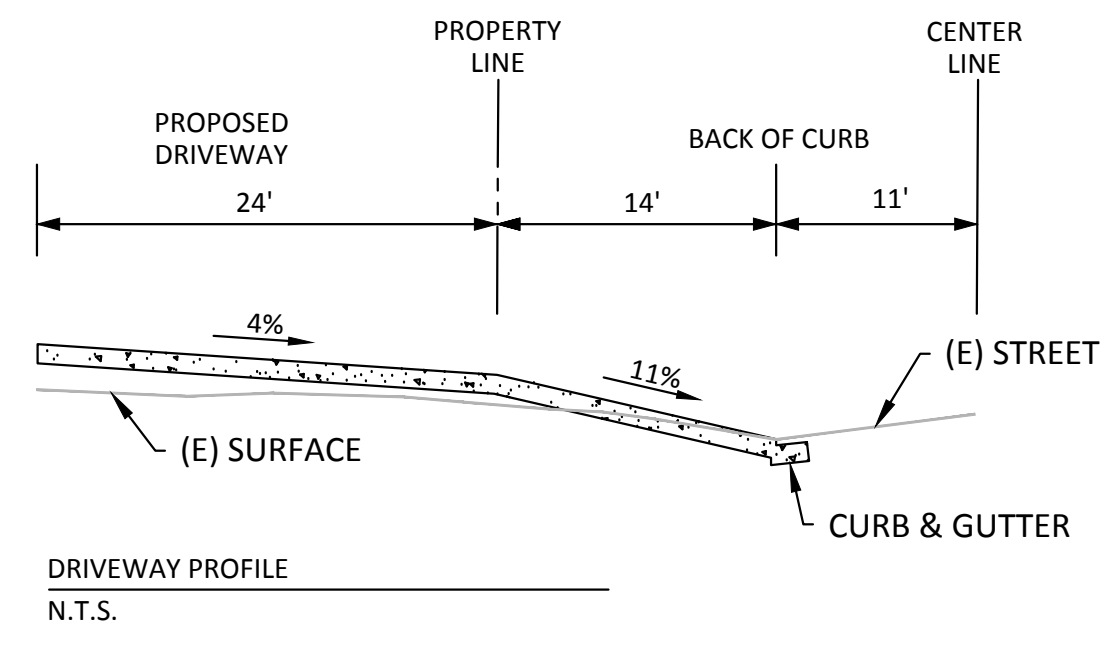

DRAINAGE CALCULATION:


(BASIN REQUIRED)

TOTAL IMPERVIOUS AREA=2,140 S.F.
 10 YEAR 1 HR. EVENT P=1.1 INCHES
 RUNOFF COEFFICIENT $C=C_{IMP} - C_{PERVIOUS}$
 $C = 0.9 - 0.4 = 0.5$
 $VOL = C \times A \times P$
 $VOL = 0.5 (1.1/12) FT \times 2,140 S.F.$
 $VOL = 98.1 C.F.$

BASIN VOLUME PROVIDED:

DETENTION PIPE
 VOLUME = $\pi R^2 \times LENGTH$
 $= \pi (9")^2 \times 45'$
 $= 106.0 CF$



VOL PROVIDED > VOL REQUIRED

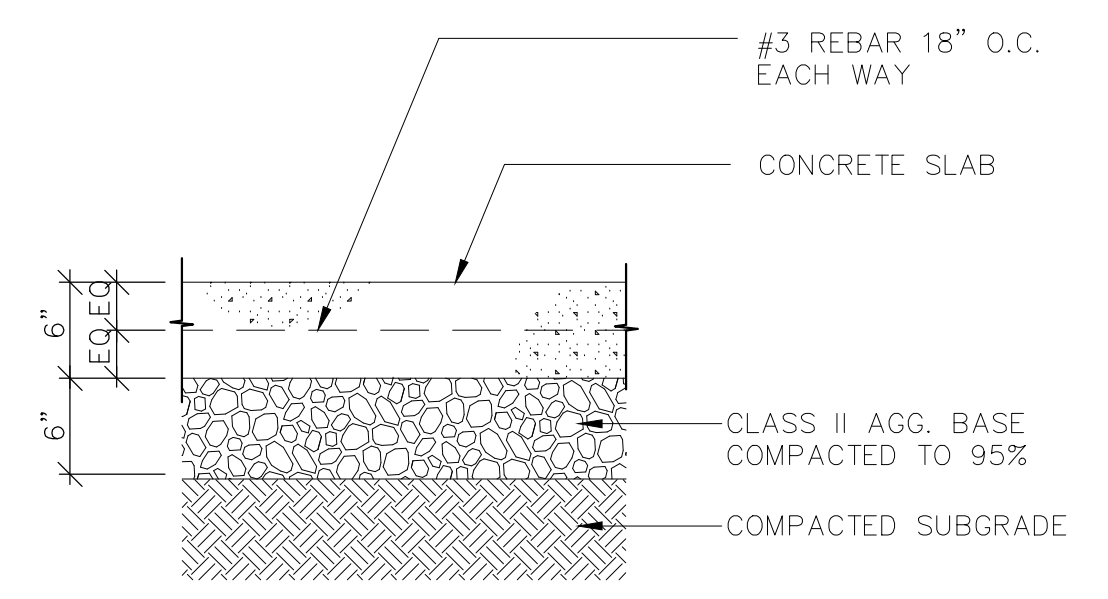

CONCRETE DRIVEWAY PAVING
SCALE: N.T.S.

NOTES:

- EXPANSION JOINTS @ 40.0' MAX.
- CONTROL JOINTS @ 10.0' O.C. MAX.

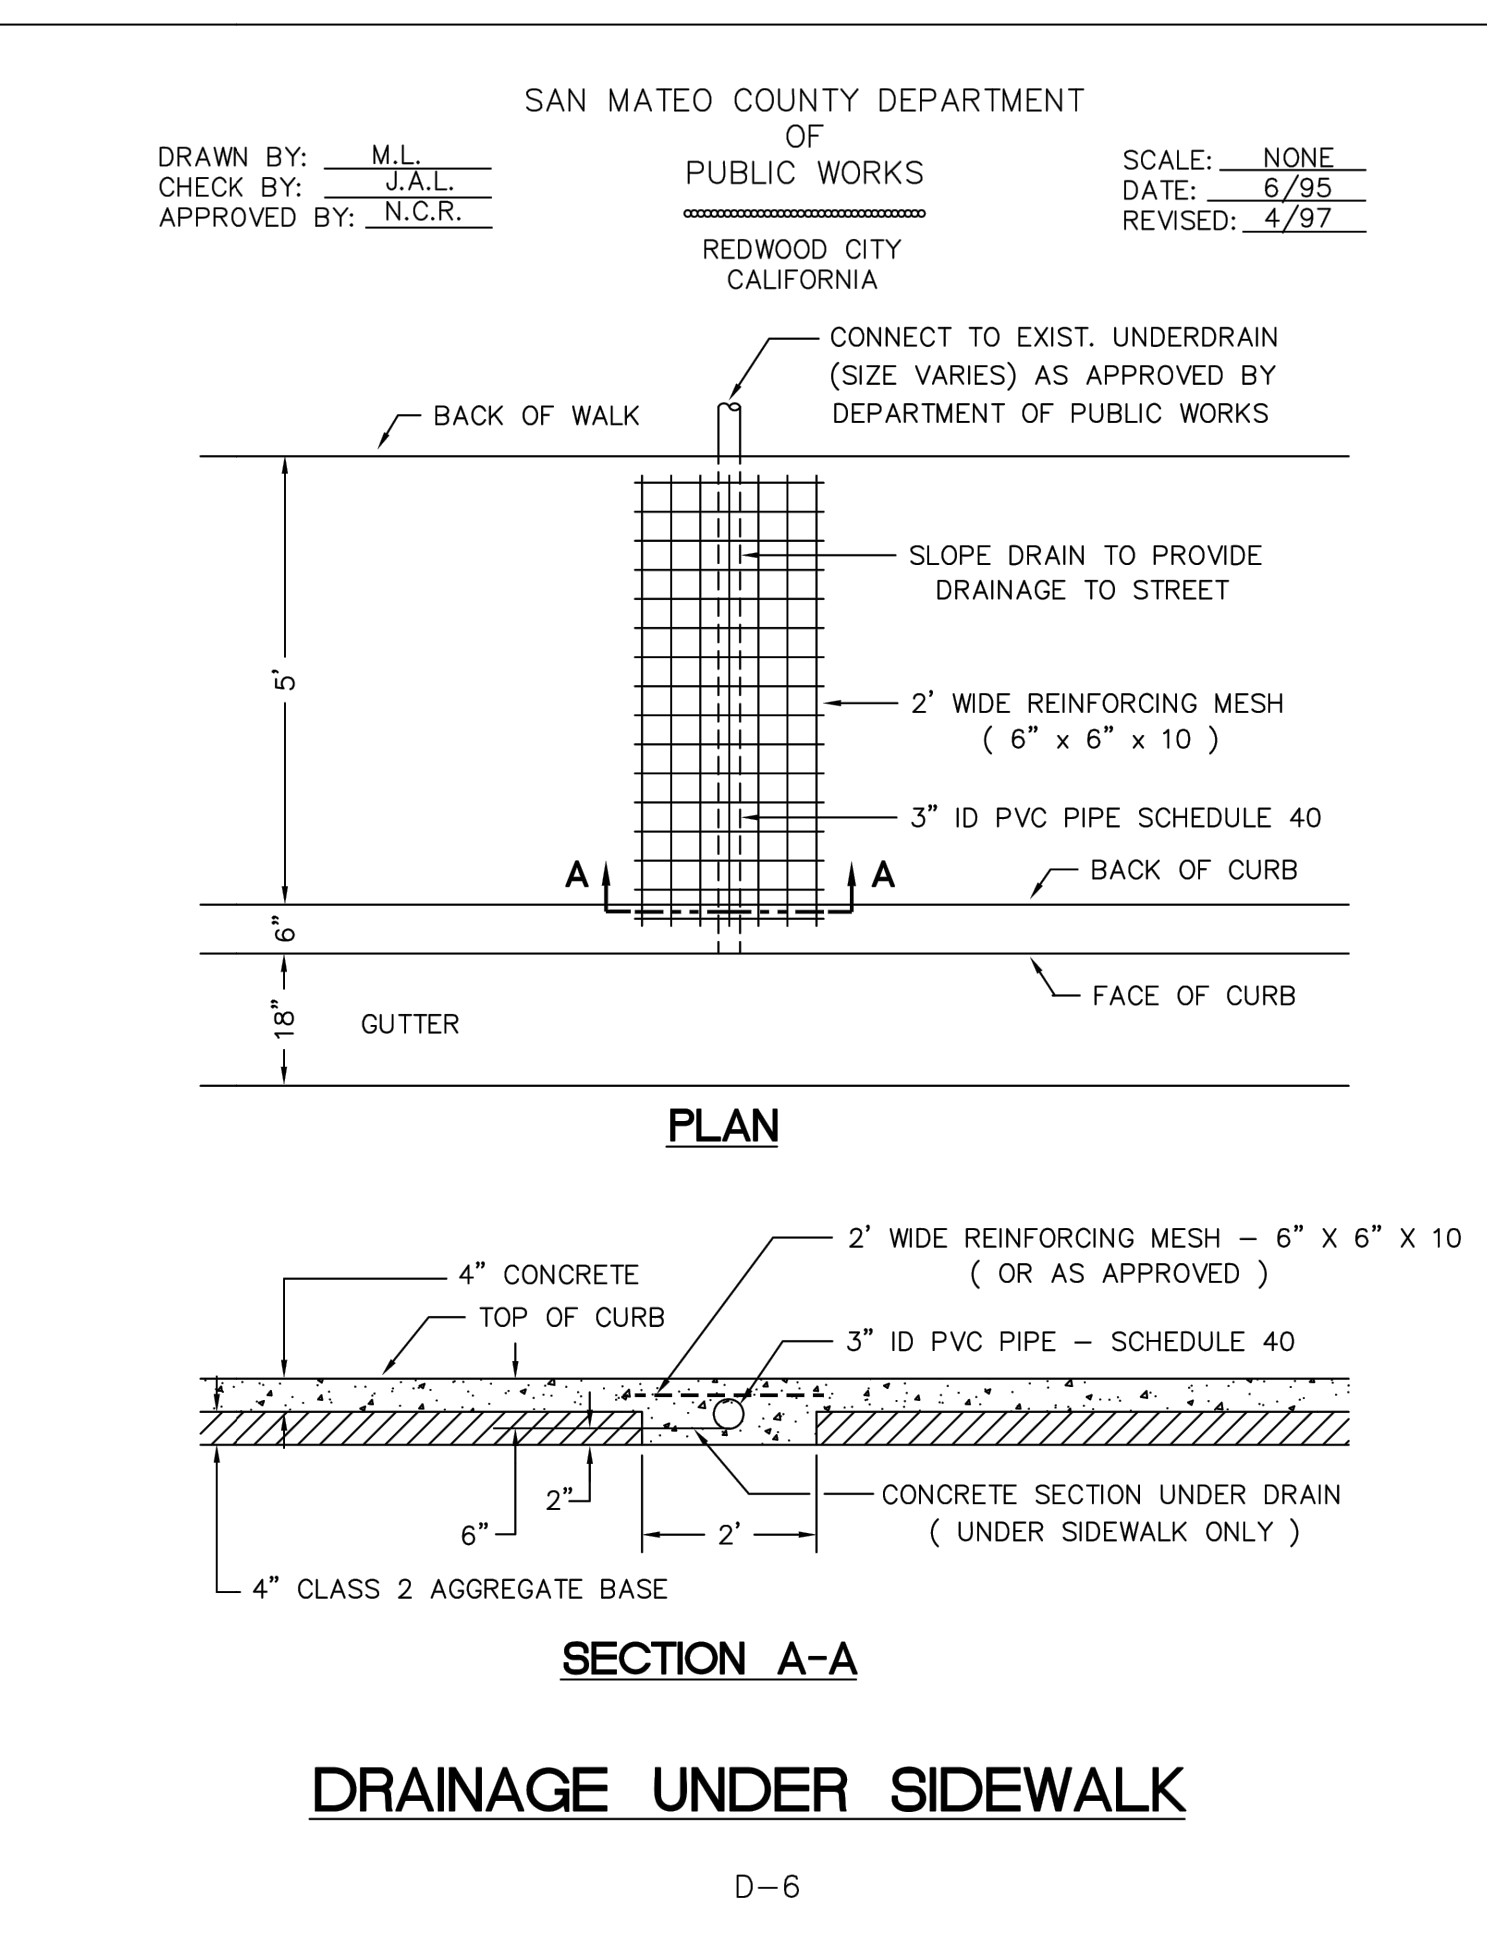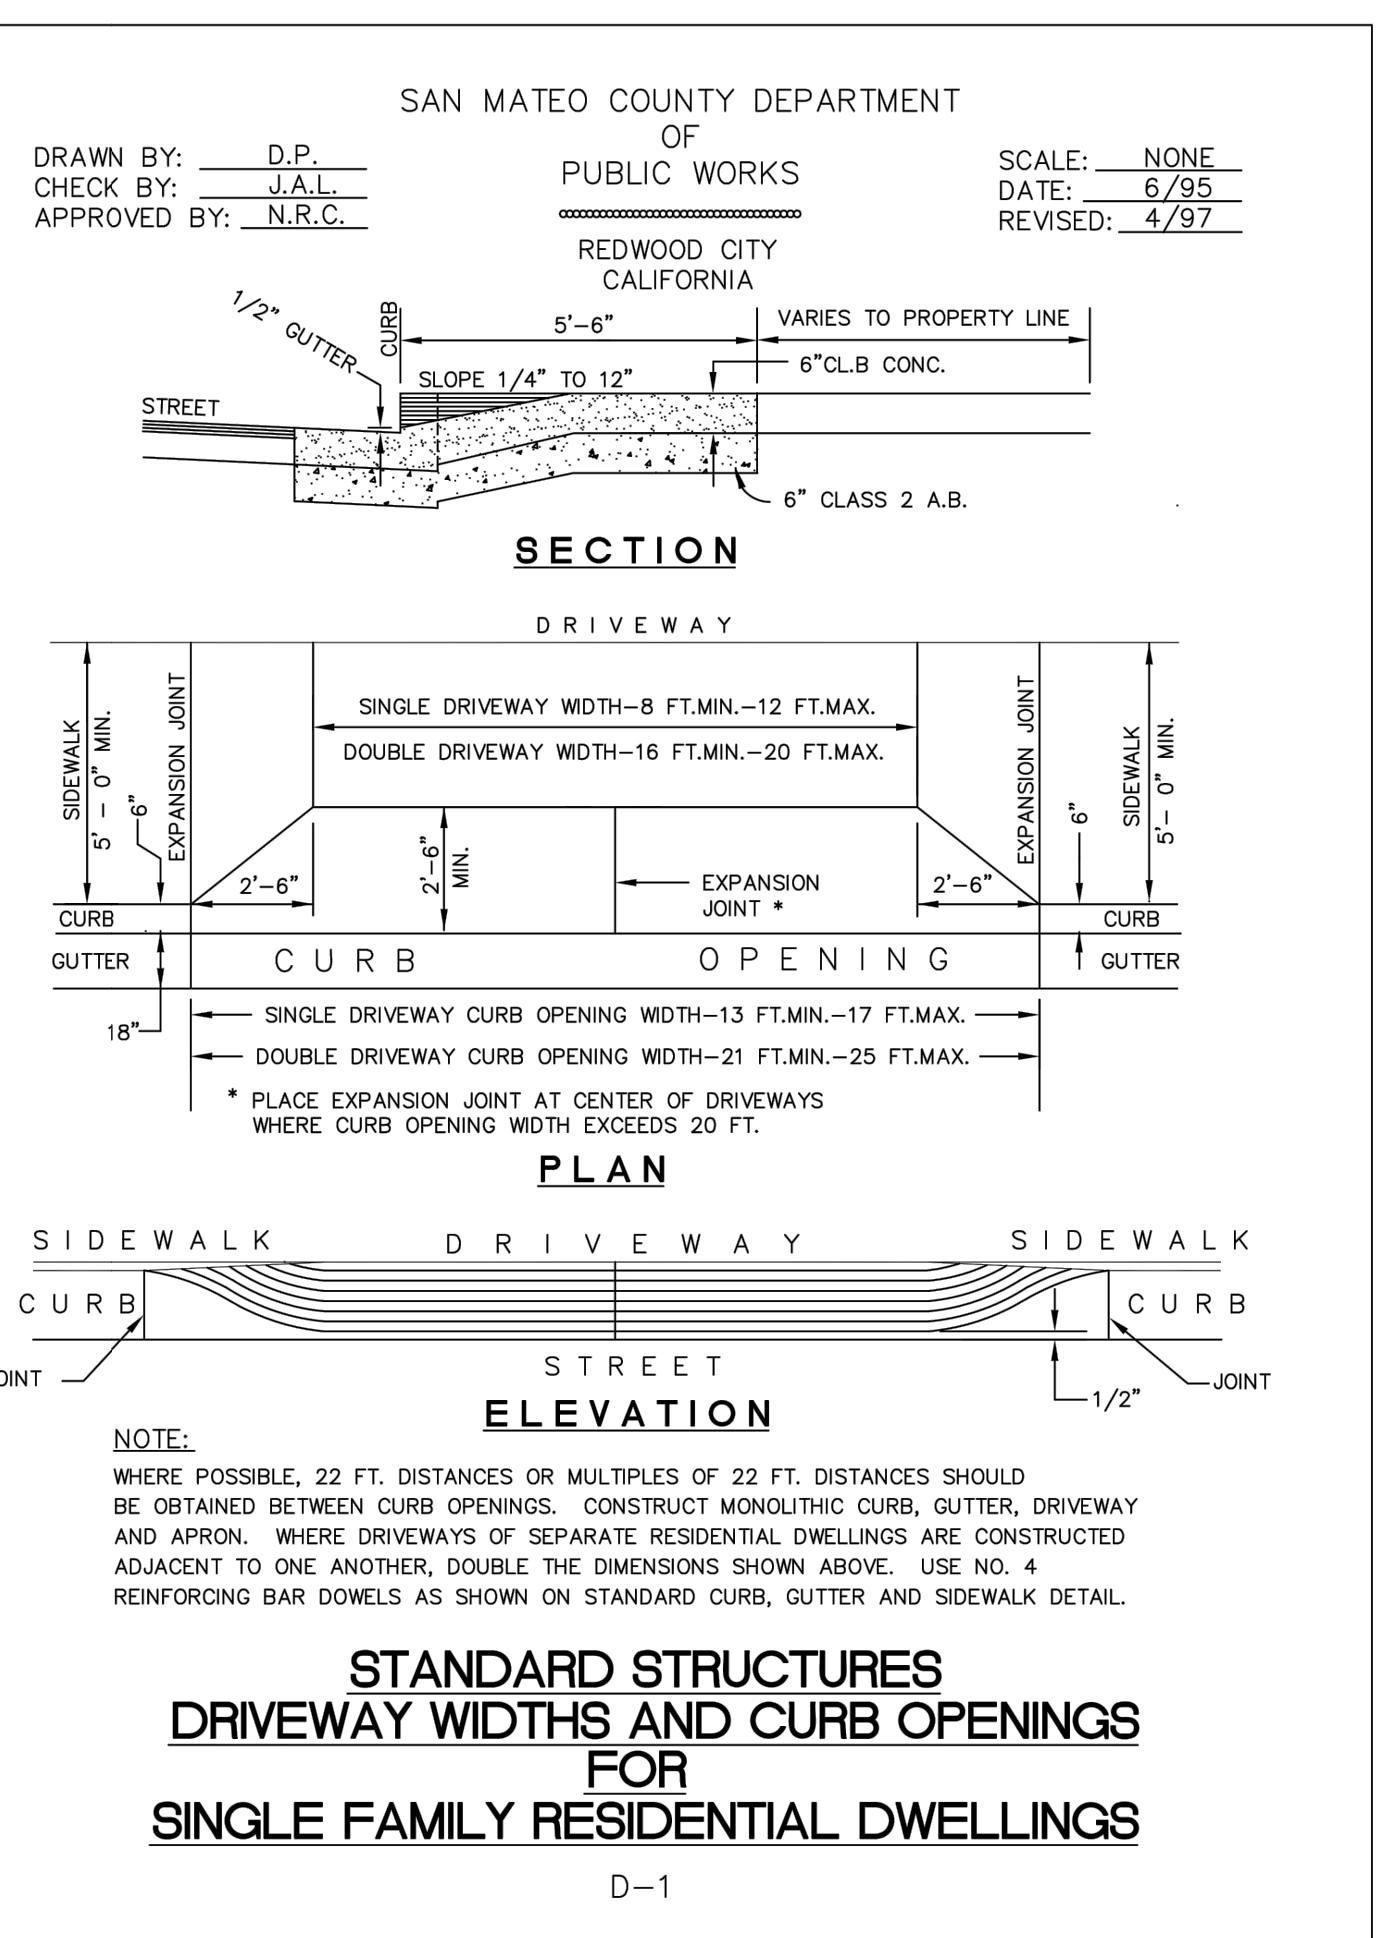


GRADING NOTES

- THE GRADING AREAS SHOULD BE PREPARED FOR GRADING BY REMOVING EXISTING VEGETATION, LARGE ROOTS, DEBRIS, AND OTHER POTENTIALLY DELETERIOUS MATERIALS. THE SITE PREPARATION OPERATIONS SHOULD BE OBSERVED BY THE GEOTECHNICAL ENGINEER.
- EXISTING UTILITY LINES THAT WILL NOT REMAIN IN SERVICE SHOULD BE EITHER REMOVED OR PROPERLY ABANDONED. THE APPROPRIATE METHOD OF UTILITY ABANDONMENT WILL DEPEND UPON THE TYPE, DEPTH, AND LOCATION OF THE UTILITY. RECOMMENDATIONS FOR ABANDONMENT CAN BE MADE AS NECESSARY.
- EXCAVATION OR OTHER REMEDIAL GRADING MEASURES MAY BE RECOMMENDED BY THE GEOTECHNICAL ENGINEER. THE OVEREXCAVATION OPERATIONS SHOULD BE OBSERVED BY THE GEOTECHNICAL ENGINEER PRIOR TO GRADING.
- THE OVEREXCAVATED SURFACES SHOULD BE CROSS-SCARIFIED TO A DEPTH OF APPROXIMATELY 8 INCHES. THE SOIL SHOULD THEN BE MOISTURE CONDITIONED TO A LEVEL ABOVE OPTIMUM MOISTURE CONTENT AND RECOMPACTED. CUT SURFACES TO RECEIVE IMPROVEMENTS SHOULD BE SCARIFIED, MOISTURE CONDITIONED, AND RECOMPACTED IN A SIMILAR MANNER.
- WATER CONDITIONING AND COMPACTION OF ON-SITE SOIL SHOULD BE PERFORMED AS RECOMMENDED ON

- THE SUB GRADE AND BASE SHOULD BE FIRM AND UNYIELDING WHEN PROOFROLLED WITH HEAVY, RUBBER-TIRED EQUIPMENT PRIOR TO CONTINUING CONSTRUCTION. THE SUBGRADE SOIL SHOULD BE PERIODICALLY MOISTENED AS NECESSARY PRIOR TO PLACEMENT OF THE AGGREGATE BASE TO MAINTAIN THE SOIL MOISTURE CONTENT ABOVE OPTIMUM.
- DUE TO THE FINE-GRAINED NATURE OF THE UPPER SOILS, THERE IS A POTENTIAL FOR THE SOILS TO BECOME UNSTABLE DURING GRADING. UNSTABLE SOILS HINDER COMPACTIVE EFFORT AND ARE INAPPROPRIATE FOR
- PLACEMENT OF FILL. ALTERNATIVES TO CORRECT INSTABILITY INCLUDE AERATION TO DRY THE SOILS AND THE USE OF GRAVEL OR GEOTEXTILES, AND CHEMICAL (QUICKLIME/CEMENT) TREATMENT AS STABILIZING MEASURES. RECOMMENDATIONS FOR STABILIZATION SHOULD BE PROVIDED BY THE GEOTECHNICAL ENGINEER AS NEEDED DURING CONSTRUCTION.
- CUT AND FILL SLOPES SHOULD NOT BE STEEPER THAN 2:1, MEASURED HORIZONTALLY TO VERTICALLY.
- THE CONTRACTOR SHALL REQUIRE WATER TRUCKS TO OPERATE IN CONJUNCTION WITH GRADING EQUIPMENT AND APPLICATION OF WATER SHALL BE MADE AS FREQUENTLY AS

- MAINTENANCE NOTE:**
- IT SHALL BE THE OWNER'S RESPONSIBILITY TO ENSURE THAT ALL DRAINAGE IMPROVEMENTS SHOWN HEREON ARE MAINTAINED IN GOOD WORKING ORDER. THIS INCLUDES PERIODICALLY INSPECTING THE STORM DRAIN PIPES FOR SEDIMENT AS WELL AS THE DRAIN INLETS FOR SEDIMENT. ANY BUILT UP SEDIMENT SHOULD BE PERIODICALLY CLEANED TO ENSURE THE DRAINAGE FEATURES FUNCTION AS INTENDED. THE SWALES ALONG THE SIDES OF THE BUILDING SHALL BE MAINTAINED AS SHOWN PER THIS PLAN.

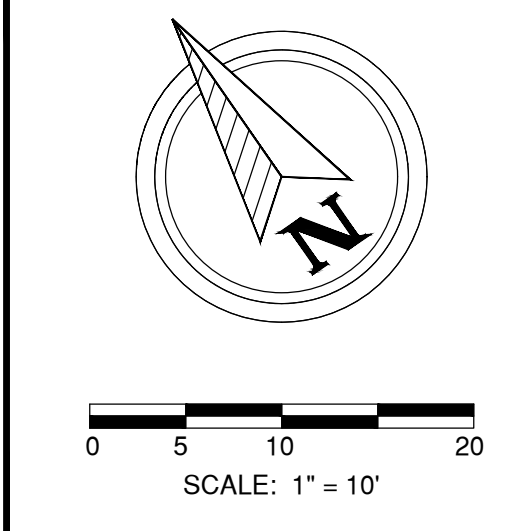



11/29/2018


MARK	DATE	REVISION
1	1-29-18	RESPONSE TO COMMENTS
2	11-29-18	RESPONSE TO COMMENTS

NEW S.F.R. CONSTRUCTION FOR
 DEWEET RESIDENCE
 VIRGINIA AVENUE
 MOSS BEACH, CA 94038

Project Number
 CTE17006

Sheet Name
 UTILITY PLAN



Sheet Number
C3

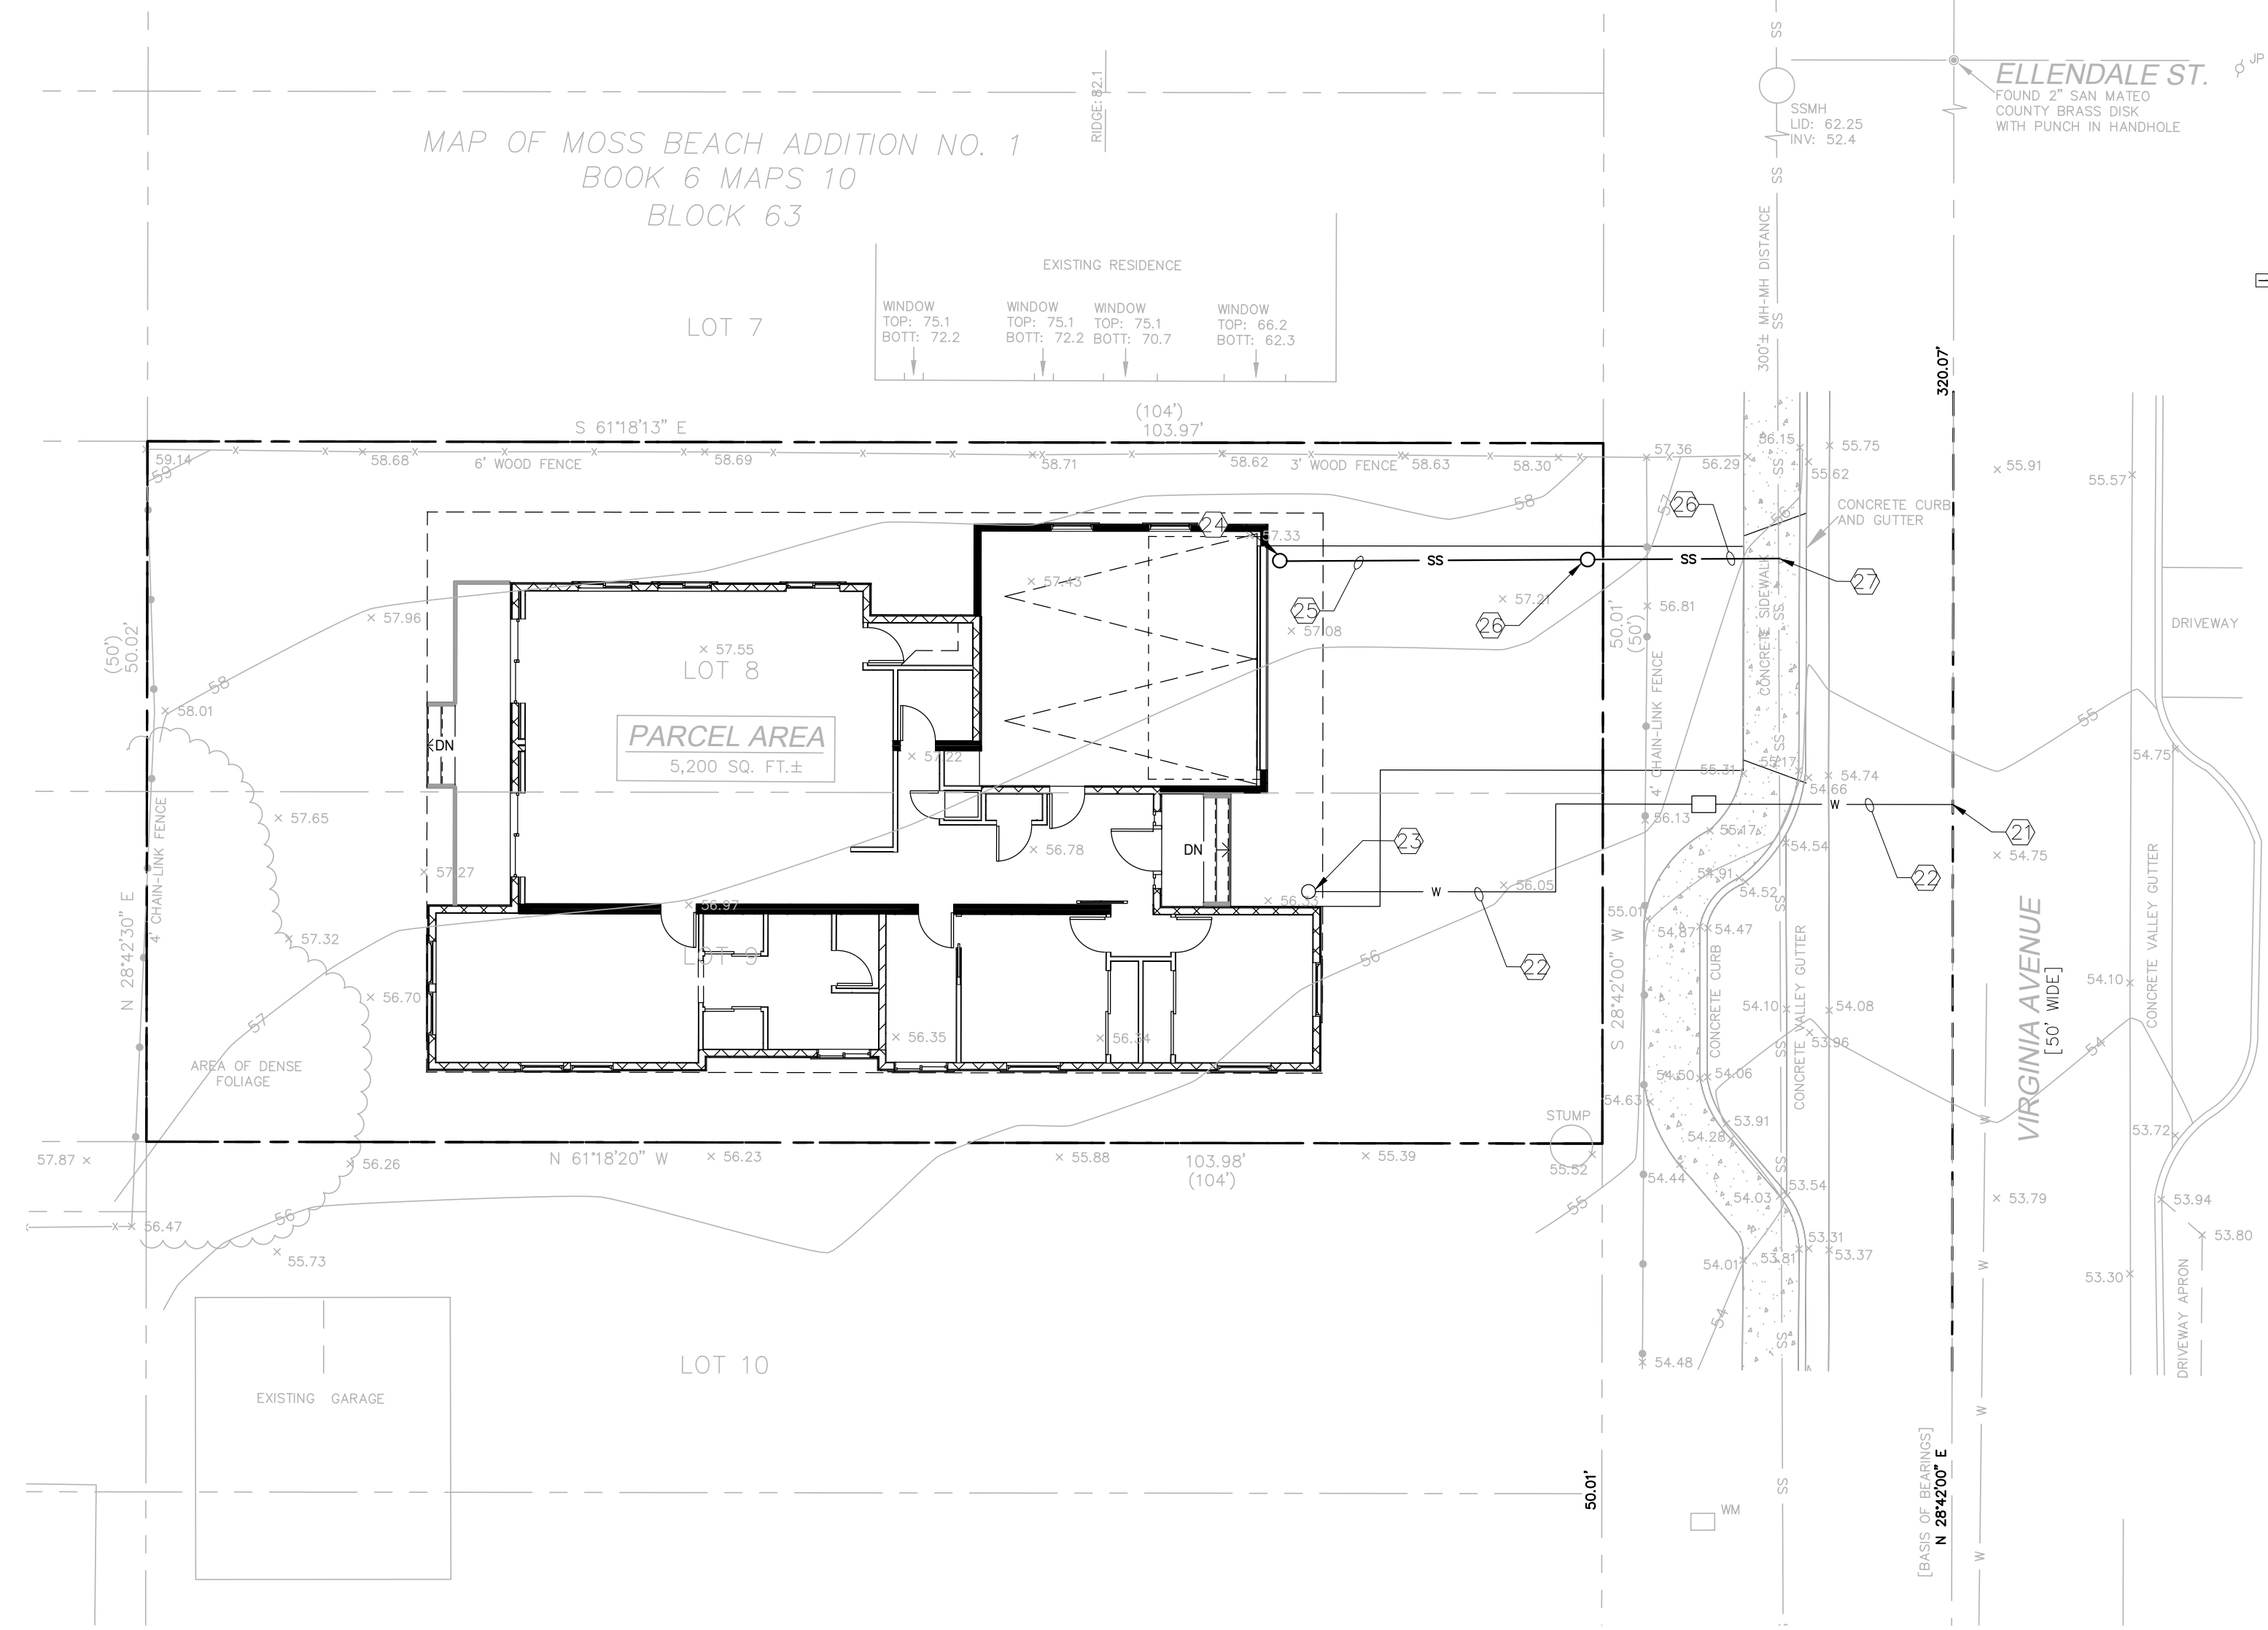


KEY NOTES:

ITEM	DESCRIPTION
21	PROVIDE NEW WATER METER. METER SIZE REFER TO MECHANICAL DRAWING. CONNECT PROPOSED WATER LATERAL TO WATER MAIN PER MONTARA WATER & SANITARY DISTRICT STANDARDS. TRENCH BACKFILL PER DETAIL SD-4.0 ON THIS SHEET.
22	NEW 1" DOMESTIC WATER LINE: TYPE "K" COPPER
23	P.O.C. 1" DOMESTIC WATER: REFER TO PLUMBING PLANS FOR MORE DETAILS.
24	P.O.C. 4" SEWER: ADD CLEANOUT TO GRADE PER DETAIL ON THIS SHEET.
25	NEW 4" SEWER LINE: SDR-26 PVC AT 0.02 SLOPE MINIMUM.
26	NEW SEWER CLEANOUT AND LATERAL: REFER TO MONTARA WATER & SANITARY DISTRICT STANDARD DETAILS SD-5 AND SD-6.
27	SEWER MAIN SIZE WAS NOT PROVIDED: CONTRACTOR TO LOCATE SEWER MAIN LOCATION, VERIFY SIZE, AND PROVIDE LATERAL CONNECTION. CONTACT ENGINEER IF THERE ARE ANY CONFLICTS.


UTILITY LEGEND:

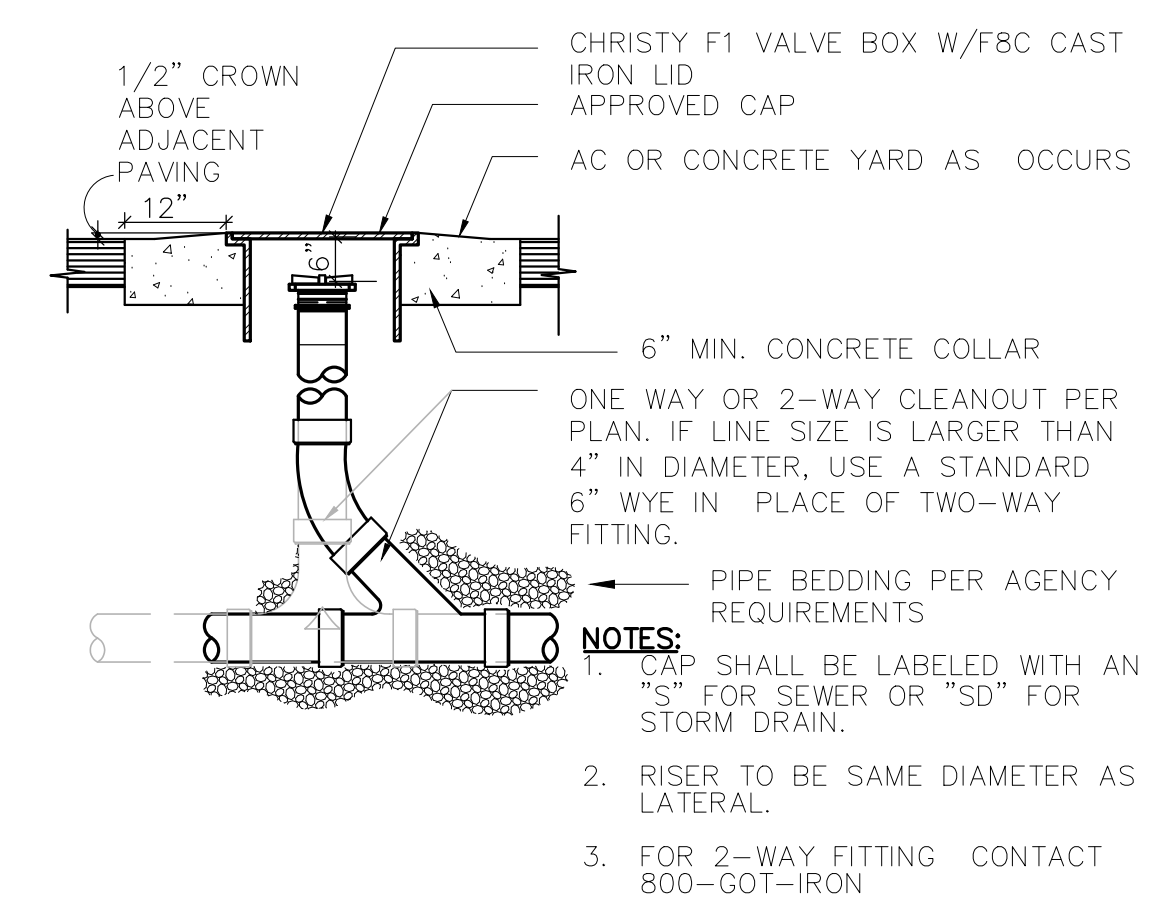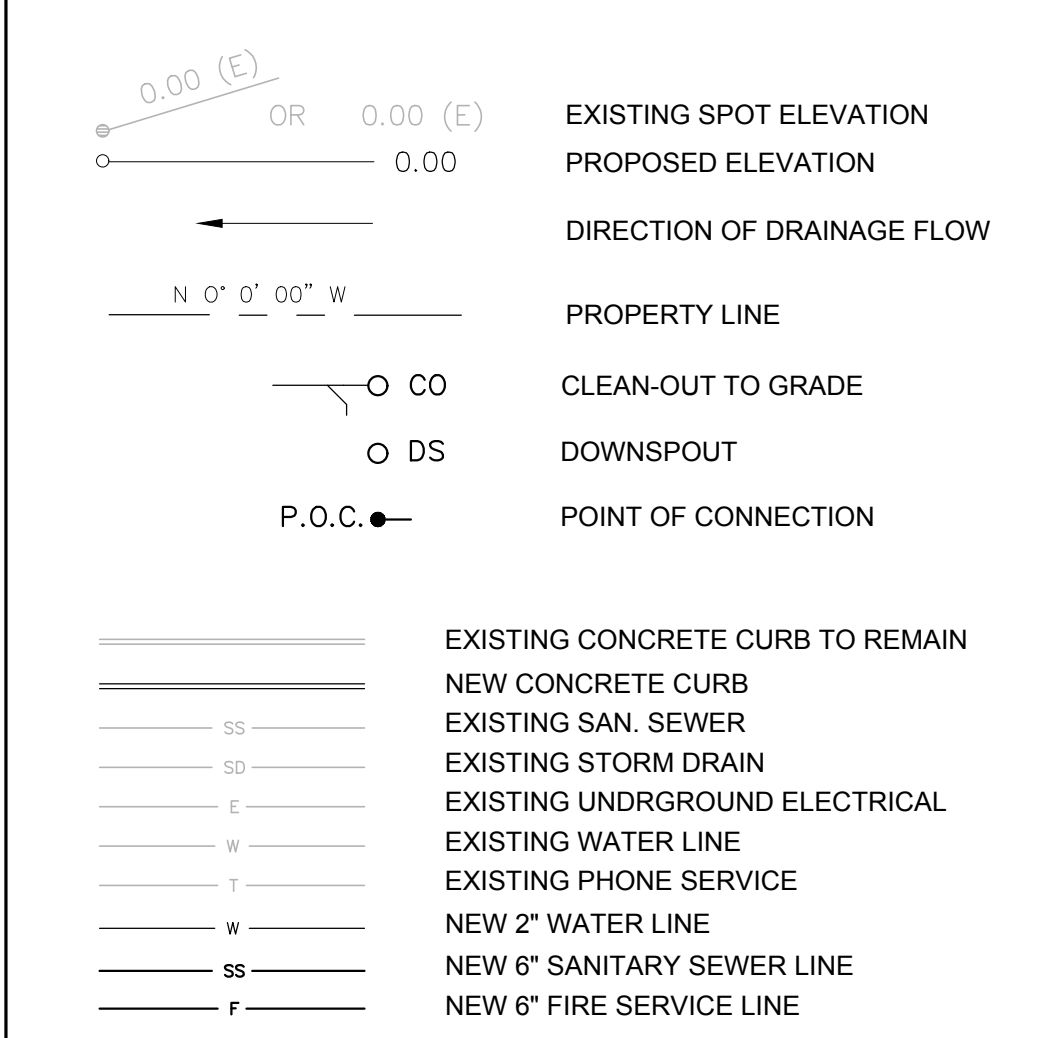


24 CLEANOUT TO GRADE

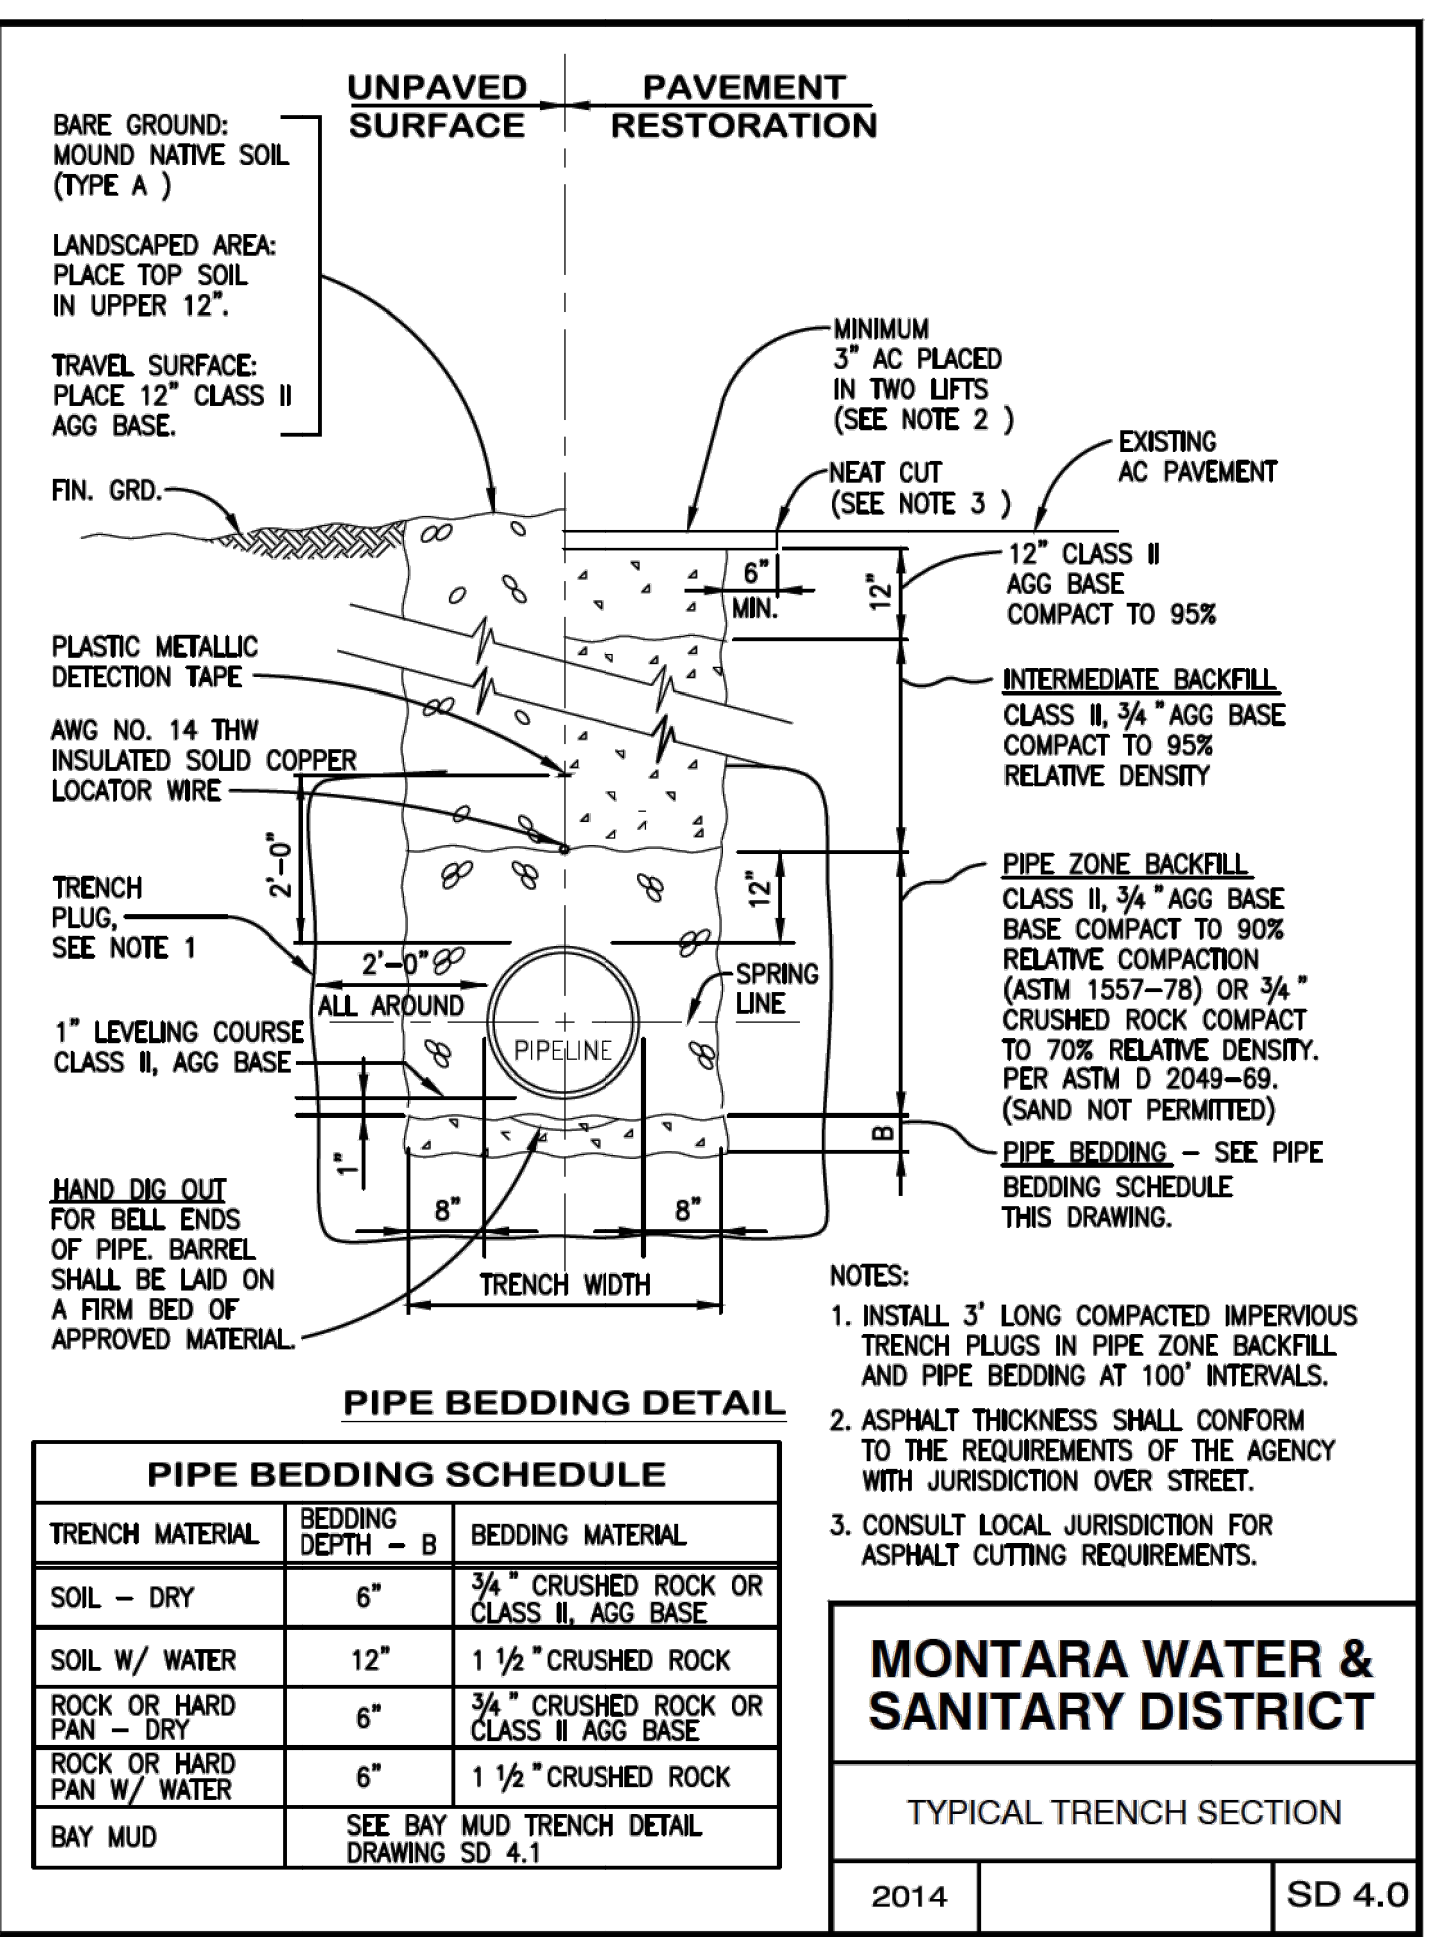

MONTARA WATER & SANITARY DISTRICT
 TYPICAL TRENCH SECTION
 2014 SD 4.0

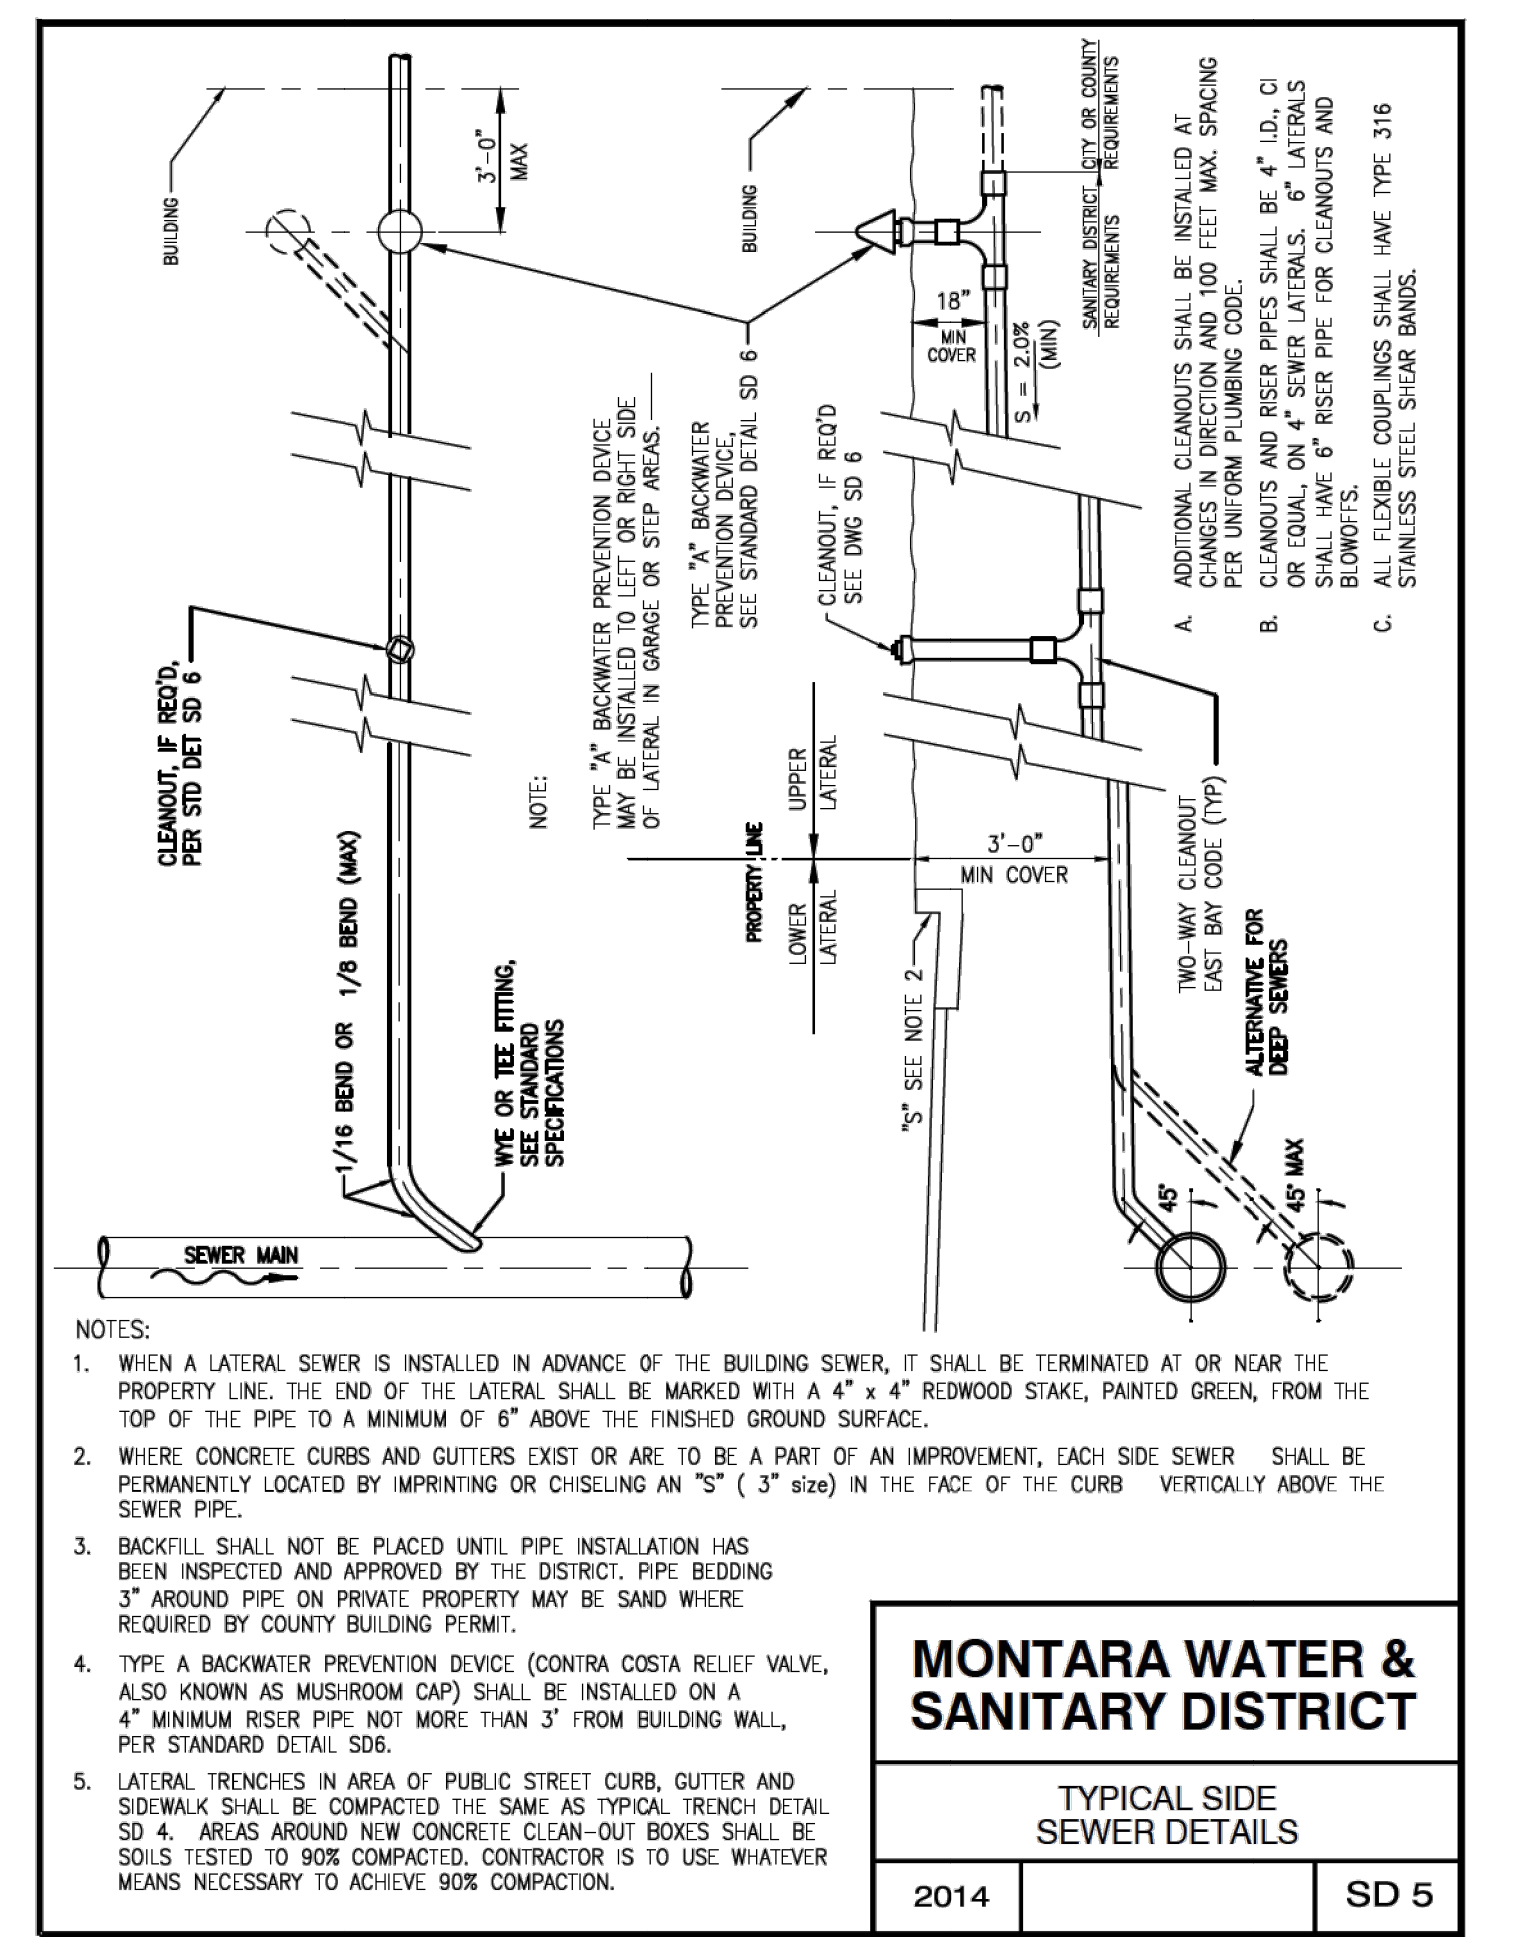

MONTARA WATER & SANITARY DISTRICT
 TYPICAL SIDE SEWER DETAILS
 2014 SD 5

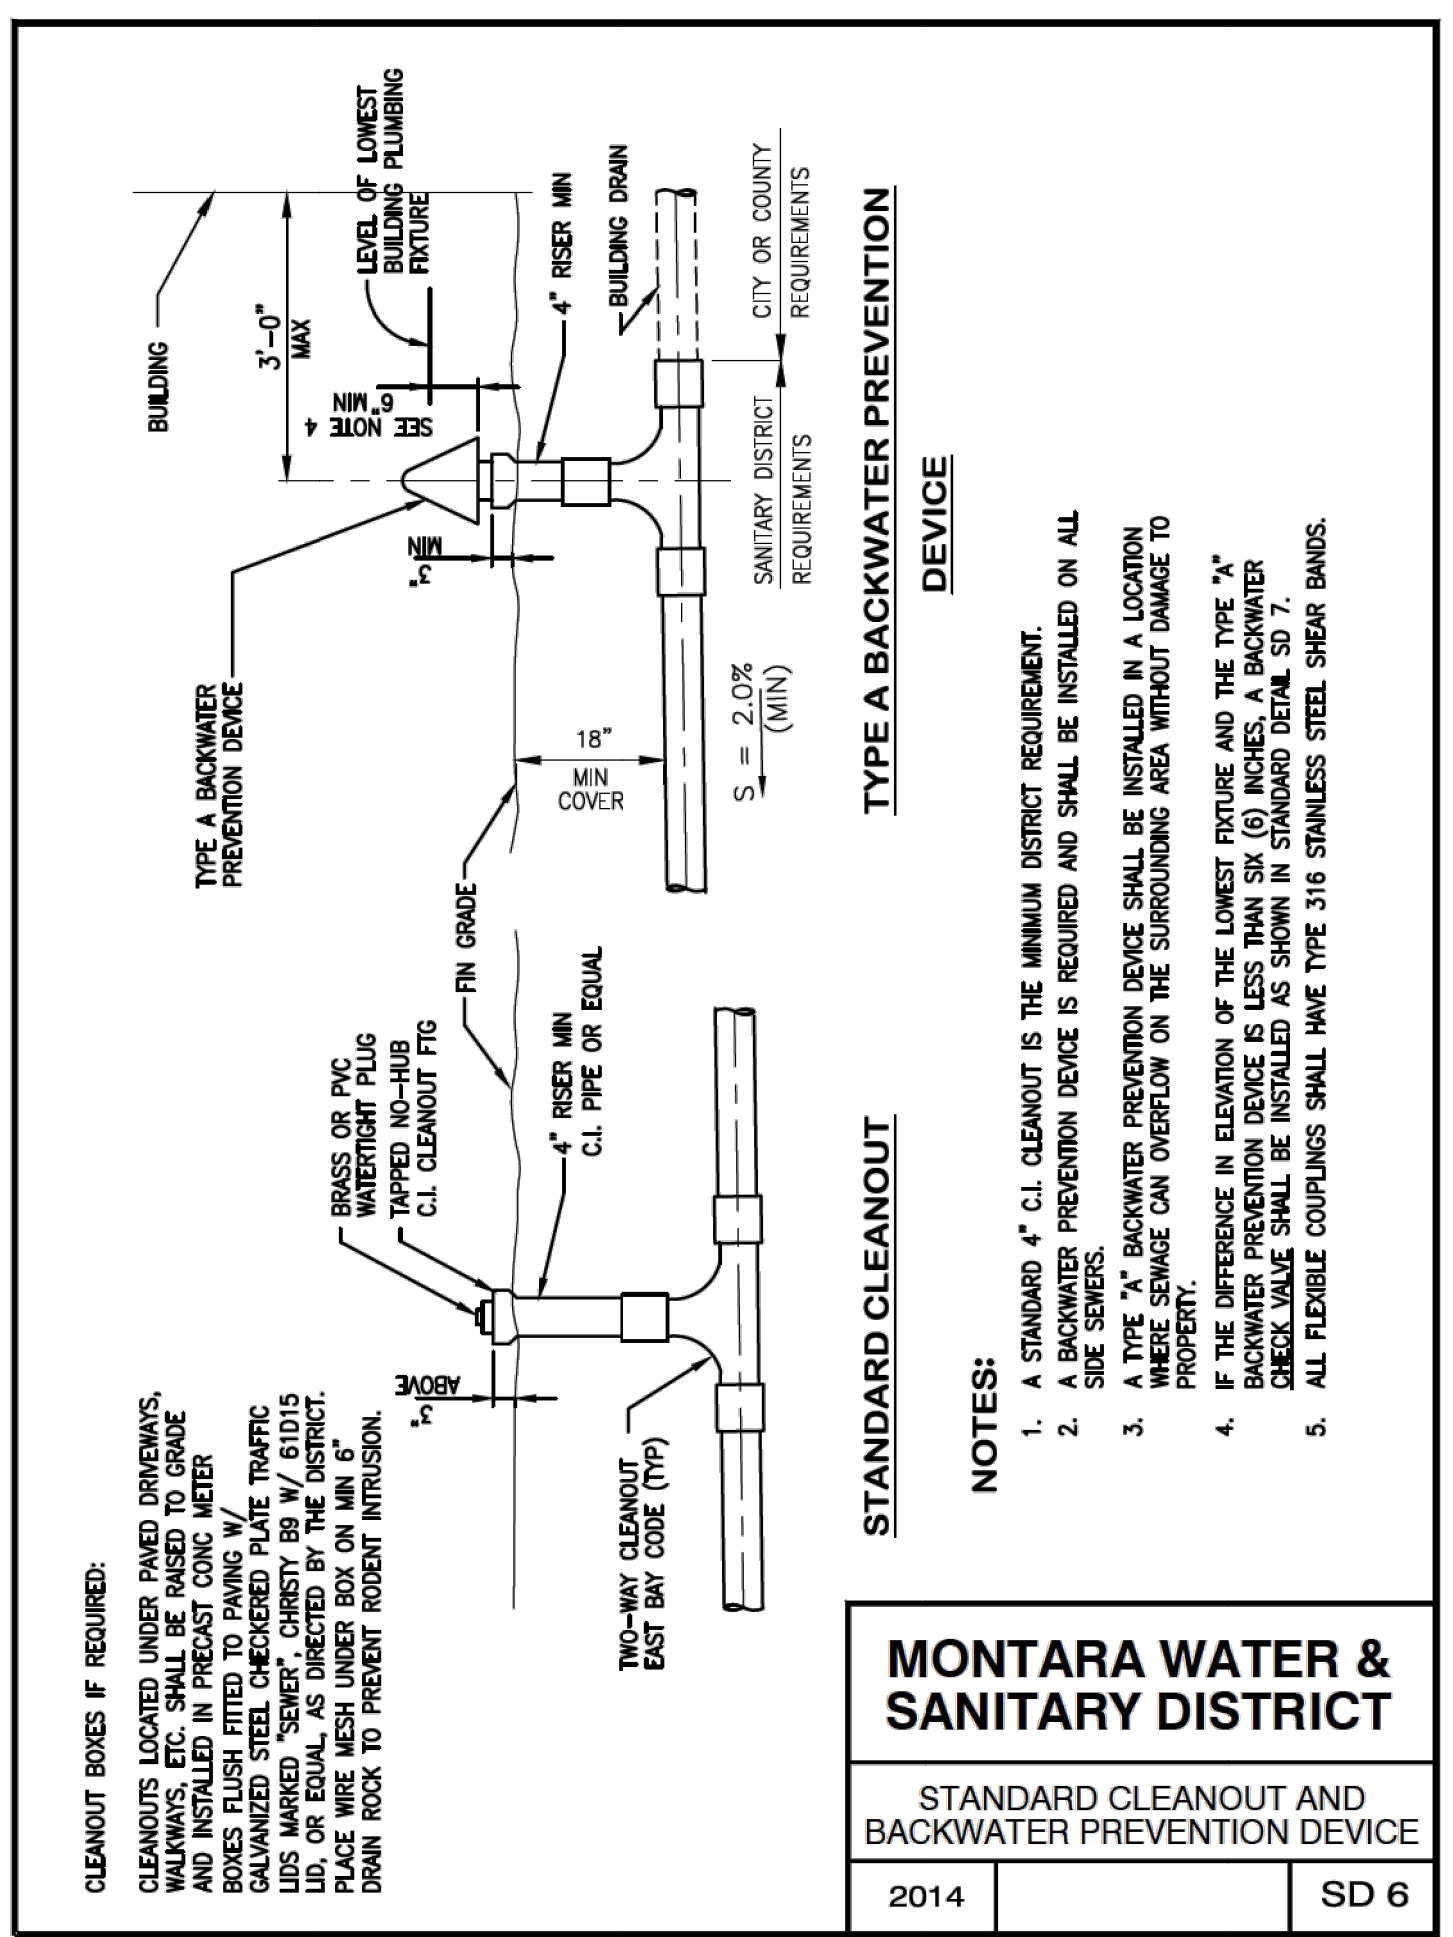


MONTARA WATER & SANITARY DISTRICT
 STANDARD CLEANOUT AND BACKWATER PREVENTION DEVICE
 2014 SD 6

UTILITY VERIFICATION:

PRIOR TO START OF ANY WORK, THE CONTRACTOR SHALL VERIFY THE LOCATION, ELEVATION AND MATERIAL TYPE FOR ALL EXISTING UNDERGROUND UTILITIES THROUGHOUT THE SITE AND AT THE POINTS OF CONNECTION. THE CONTRACTOR SHALL VERIFY THAT THE PROPOSED UTILITY SERVICE WILL MEET THE INDICATED PIPE SLOPES AND IMMEDIATELY NOTIFY THE CLIENT REPRESENTATIVE AND STANTEC OF ANY CONDITION(S) THAT WILL PREVENT CONSTRUCTION OF NEW UTILITY SERVICES AS INDICATED ON THE PLANS. THE CONTRACTOR SHALL BE FULLY RESPONSIBLE FOR ALL ADDITIONAL COST INCLUDING BUT NOT LIMITED TO REDESIGN, CONSTRUCTION, INSPECTION, AND LIQUIDATED DAMAGES RESULTING FROM THE CONTRACTOR'S FAILURE TO PERFORM UTILITY VERIFICATION.

UTILITY NOTES:

- SEE ELECTRICAL DRAWINGS FOR ELECTRICAL RUNS.
- INSTALL IRRIGATION SLEEVES MIN. 12" FROM BACK OF CURB AND MINIMUM 18" DEEP, CAP ENDS.
- PLUMBING DESIGN BASED ON MINIMUM PSI OF 65 PSI AT BACK OF EACH METER. IF PRESSURE TESTED AT THE BACK OF METER IS LESS THAN THE MINIMUM DESIGN VALUE NOTED, CONTRACTOR SHALL IMMEDIATELY NOTIFY CLIENT REPRESENTATIVE AND CONSULTANT.
- THE LOCATION OF EXISTING UNDERGROUND UTILITIES SHOWN HEREON ARE AN APPROXIMATION OF THEIR ACTUAL LOCATION AND HAVE NOT BEEN INDEPENDENTLY VERIFIED BY THE OWNER OR ITS REPRESENTATIVE. THE CONTRACTOR SHALL DETERMINE THE EXACT LOCATION OF ALL EXISTING UTILITIES BEFORE COMMENCING WORK, AND AGREES TO BE FULLY RESPONSIBLE FOR ANY AND ALL DAMAGES WHICH MAY OCCUR DUE TO THE CONTRACTOR'S FAILURE TO PHYSICALLY LOCATE AND PRESERVE ANY AND ALL UNDERGROUND UTILITIES.
- THE CONTRACTOR SHALL SECURE ALL ENCROACHMENT PERMITS FROM ALL APPLICABLE AGENCIES BEFORE THE COMMENCEMENT OF WORK.
- USE SDR-26 FOR ALL DRAIN, WASTE & VENT PIPING.

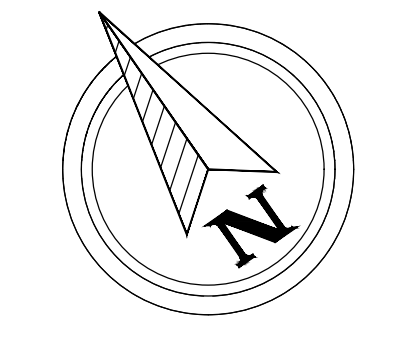

SCALE: 1" = 10'



